# 23-25 LACHLAN AVENUE, MACQUARIE PARK

DRAWING NUMBER	DRAWING TITLE	REV
TP00.00 TP01.00 TP01.01 TP01.02 TP01.03 TP01.04 TP01.05 TP01.09 TP01.16 TP01.17 TP01.18 TP02.01 TP02.02 TP03.01 TP03.05 TP05.01 TP06.05 TP11.01 TP13.01 TP13.02	COVER SHEET DEVELOPMENT SUMMARY BASEMENT 2 BASEMENT 1 BASEMENT 1 MEZZANINE GROUND GROUND MEZZANINE LEVELS 1 - 5 LEVELS 6 - 12 LEVEL 13 LEVEL 14 ROOF PLAN ELEVATIONS 01 ELEVATIONS 01 ELEVATIONS 02 SECTIONS CAR PARK RAMP SECTIONS GFA PLANS LANDSCAPE & DEEP SOIL EXTERIOR FINISHES SINGLE STUDIO TYPE 01 SINGLE STUDIO TYPE 02	D D B C D D C A C C C C D D C D D A B A
TP13.04	2 BED APARTMENT DDA	В
TP13.04 TP13.05 TP13.06 TP13.07 TP13.08	2 BED APARTMENT DDA 4 BED APARTMENT TYPE 01 5 BED APARTMENT TYPE 01 5 BED APARTMENT TYPE 02 6 BED APARTMENT TYPE 01	B B B B
TP13.09	6 BED APARTMENT TYPE 02	В



## **DEVELOPMENT APPLICATION**

Revisions

A 09.04.2021 DA SUBMISSION KW
B 20.04.2021 DA SUBMISSION RFI RESPONSE BR
C 24.08.2021 DA SUBMISSION RFI RESPONSE KW

14.04.2022 DA SUBMISSION RFI RESPONSE BR






#### 2.0 Urban Context & Site Analysis 2.01 Site Context

#### **Existing Site Context**

The site is located within the Macquarie Park precinct, south of Macquarie shopping centre and Macquarie University.

The existing site is currently 2 separate lots with low rise apartment buildings. The surrounding precinct is characterised by similar 2,3 and 4 storey apartment buildings sitting on small to medium sized allotments.



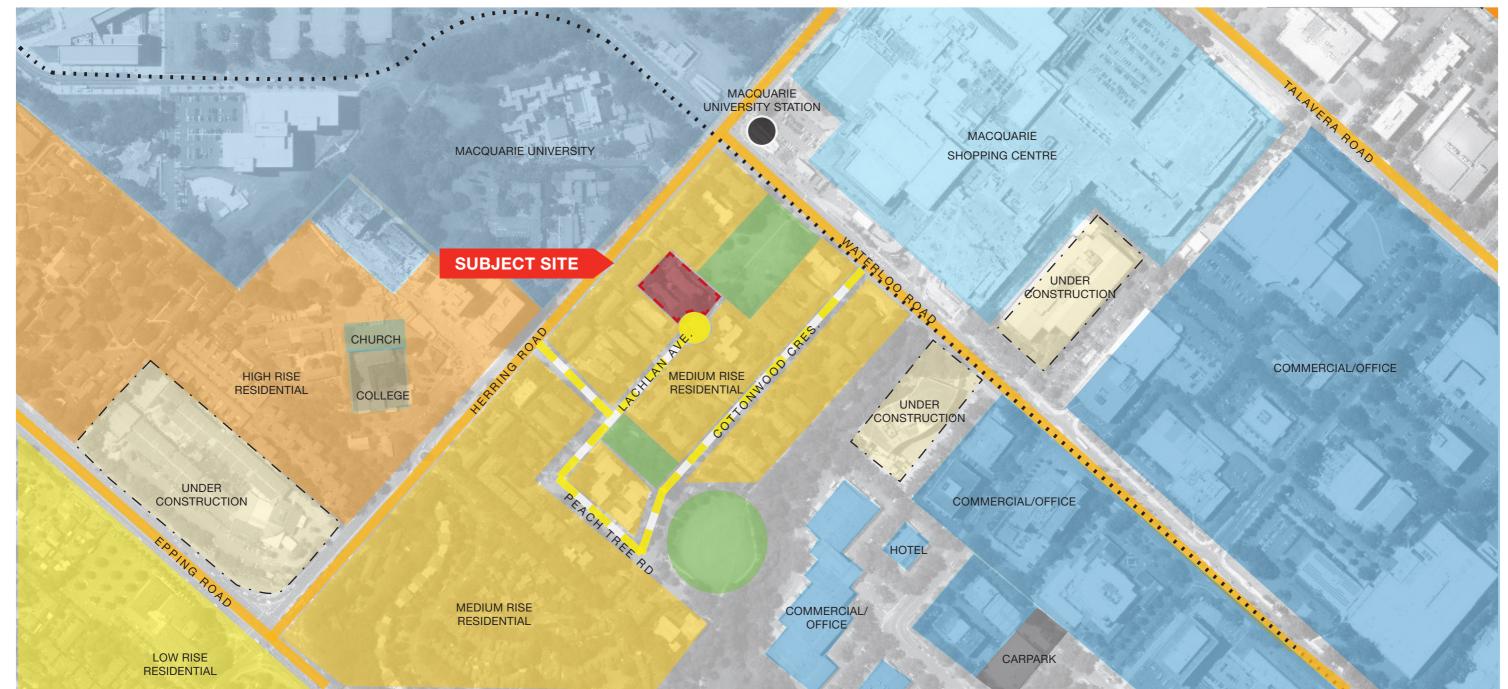


#### **Transport Links**

The site is well connected for public transport, being inside 400m walking distance from the Macquarie University Station. Similarly major bus routes are located within 200m walk adjacent to Waterloo road.


The site is also well connected to local bike path networks and directly to open space.



Legend

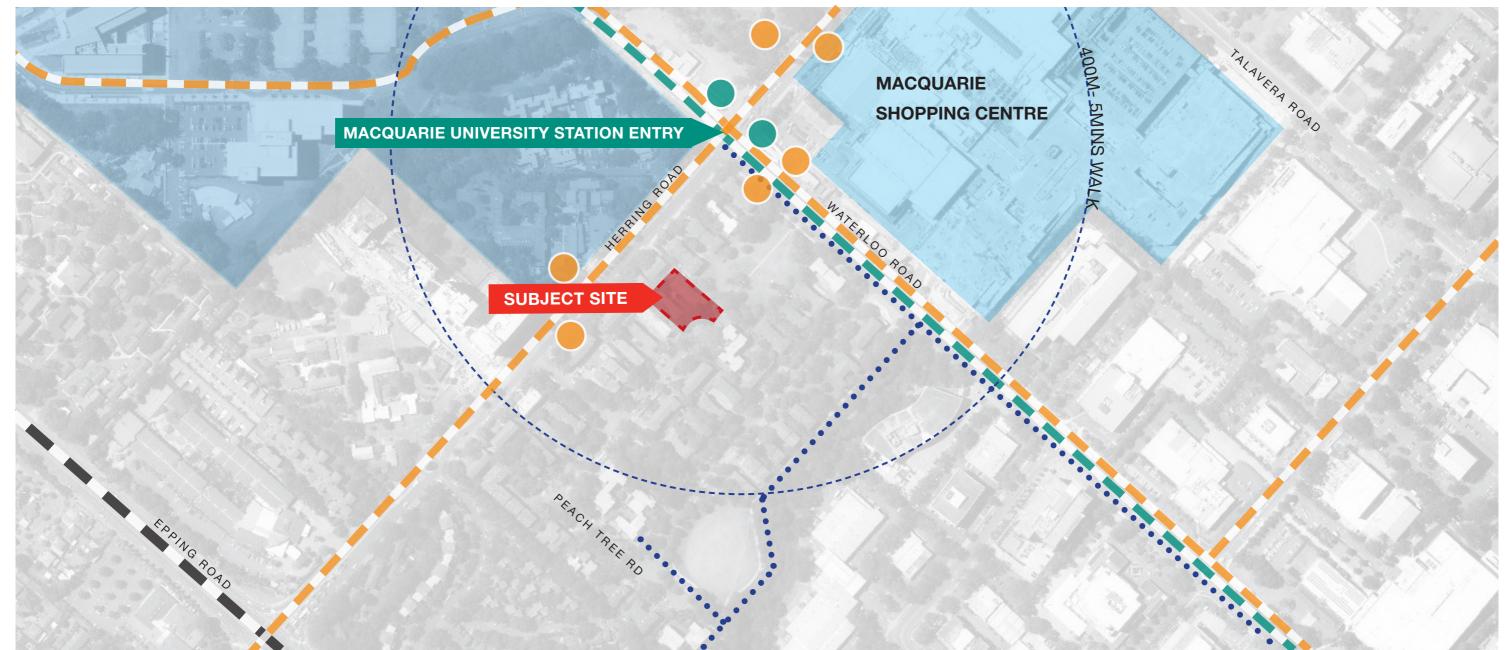

#### 1.0 Urban & Cultural Context 2.07 Opportunities & Constraints

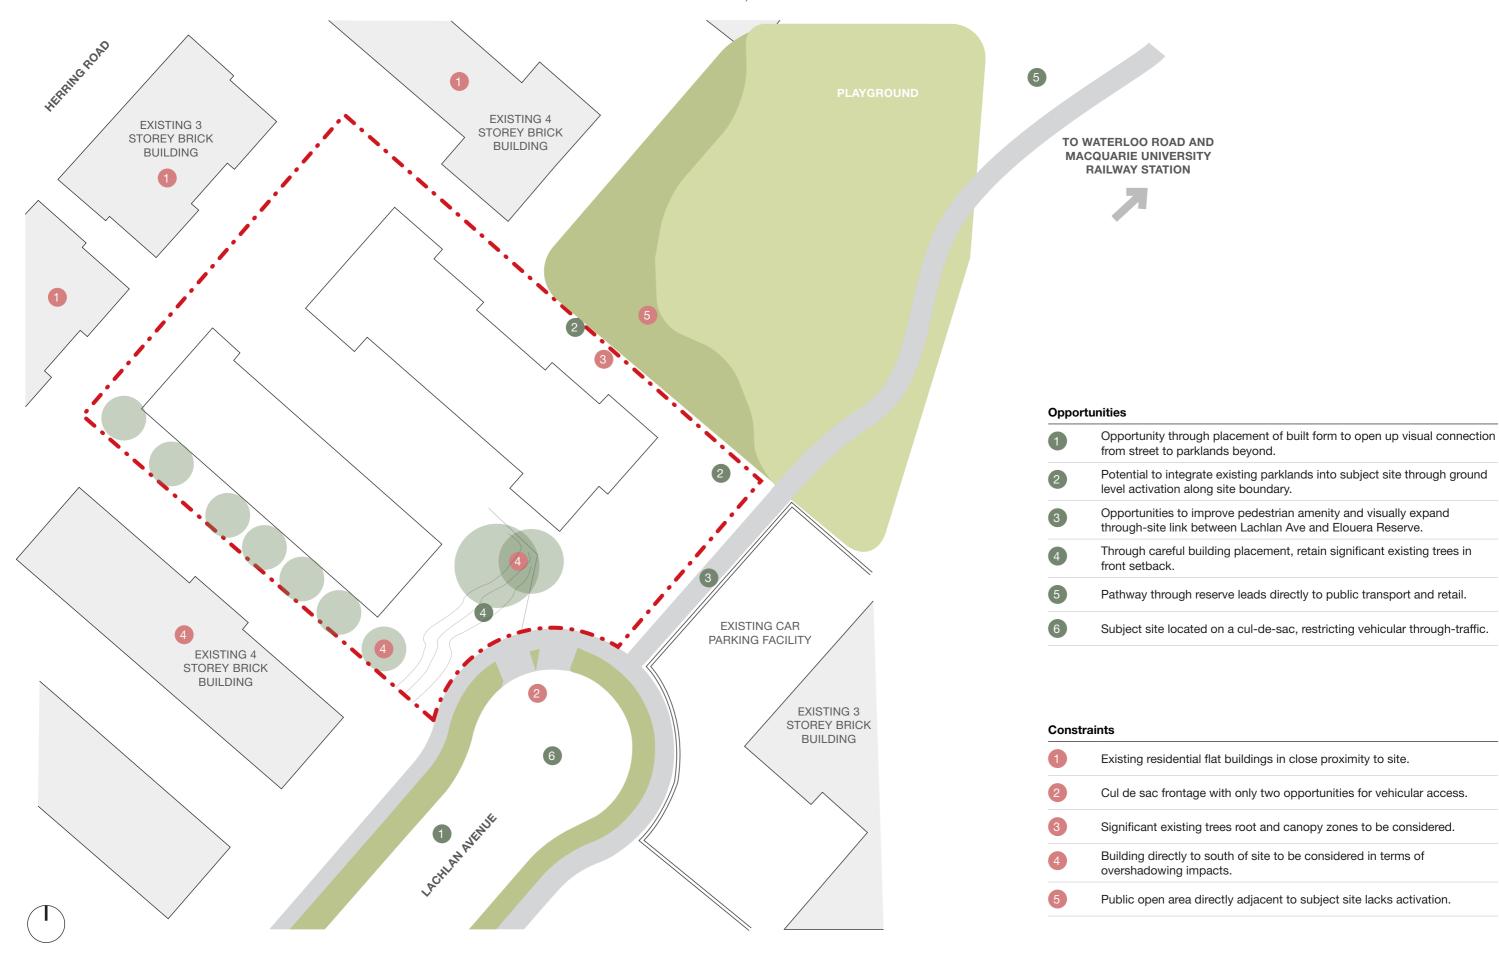

#### 3.0 Design Evolution & Response 3.03 Key Design Evolutions

#### **Key Design Evolutions in Response to Pre-DA Meetings**

Significant aspects of the Scheme were supported by the Urban Design Review Panel at its meeting in late 2019. As part of developing the design, suggestions made by the panel have been integrated wherever possible.

The key amendments made in response are itemised below, with the relevant subheading from the panel design minutes referenced:

#### 1.CONTEXT AND NEIGHBOURHOOD CHARACTER

Further detailed assessment of the existing trees has lead to the relocation of the proposed driveway away from the park side of the development. One existing tree will be removed, however the significant Gums in the centre of the site have had their surrounding landscape increased, and importantly lines of sight towards the park have been opened up.

The removal of the ramp from this interface resolves a previously complicated junction and allows for the replacement of the removed tree with a large and contigous deep soil planted area.

#### 2. CONTEXT AND NEIGHBOURHOOD CHARACTER

Detailed assessment of the neighbouring existing buildings have been made, and are incorporated in both the detailed shadow studies, and adjacent site schematics to demonstrate their ability to be developed in the future.

#### 3.CONTEXT AND NEIGHBOURHOOD CHARACTER

In order to create the large landscaped buffer at the South-Eastern corner of the site, the basement carpark is partially located towards the rear setback. The constraint of large waste vehicles accessing the basement generate the Western wall position of the basement carpark. In order to provide for the large tree planting recommended by the panel, Structural deep soil zones have been added along this rear space in order to create a tree canopy.

#### **4.BUILT FORM AND SCALE**

Further articulation has been added to the Western, and Southern facades in order to improve the presentation of the form from these neighbours and create visual relief suggested by the Design Panel.

#### 5. LANDSCAPE

As per previous notes, after detailed consideration and work with our arborist, the driveway access point has been relocated to significantly improve the front address and interface to the park. Trees along the park boundary are also able to be retained in this new configuration as the excavation line is outside their TPZ.

The location of more noisy/active uses has been defined in the plans in order to provide greater acoustic privacy for neighbours, with these games uses positioned facing the park and away from rear boundaries. Passive, outdoor lounge and study areas are instead located in this position.

#### 6. AMENITY


Significant design development has been undertaken on the communal areas both at ground, and each level of the building and details are included in this design report. The areas of communal space on each level has been increased with both external and internal areas. Multi-bedroom accomodation has been included, with living spaces to each of these clusters increased in area, with detail plans demonstrating internal furniture included in the application.

#### 7. SAFET

Definition of the security line around the perimeter of the building in order to create clearly delineated public and private areas has been undertaken and included in the plans.

#### 8. AESTHETICS

Detailed design work with the client, contractors and engineers has developed a more detailed facade response that satisfies the sustainability objectives of the project - high passive solar responsiveness, and details of this are included in the documentation.

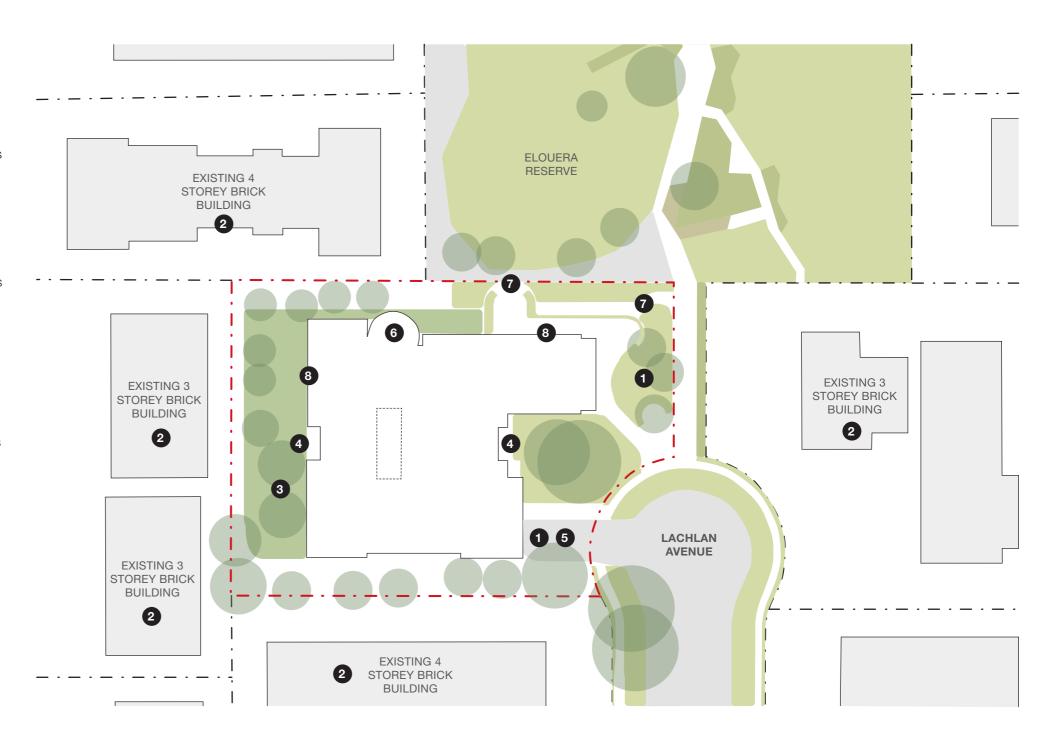

## DEVELOPMENT SUMMARY

LEVEL	COMMUNAL AREAS	OFFICE / MANAGEMENT AREAS	SINGLE	DOUBLE	DDA (2 BEDS)	MANAGERS (3 BEDS)	No. 4 BEDS	No. 5 BEDS	No. 6 BEDS	No. 7 BEDS	TOTAL No. ROOMS	TOTAL No. BEDS / OCCUPANCY
BASEMENT 2	0.0 m <sup>2</sup>	0.0 m <sup>2</sup>	0	0	0	0	0	0	0	0	0	0
BASEMENT 1	0.0 m <sup>2</sup>	0.0 m <sup>2</sup>	0	0	0	0	0	0	0	0	0	0
BASEMENT MEZZ	284.1 m²	0.0 m <sup>2</sup>	0	0	0	0	0	0	0	0	0	0
GROUND	500.3 m <sup>2</sup>	37.5 m <sup>2</sup>	0	0	0	1	0	0	0	0	1	3
MEZZANINE	0.0 m <sup>2</sup>	0.0 m <sup>2</sup>	0	0	0	0	0	0	0	0	0	0
LEVEL 1	36.8 m <sup>2</sup>	0.0 m <sup>2</sup>	26	0	1	0	1	1	0	0	29	37
LEVEL 2	36.9 m <sup>2</sup>	0.0 m <sup>2</sup>	26	0	1	0	1	1	0	0	29	37
LEVEL 3	36.8 m <sup>2</sup>	0.0 m <sup>2</sup>	26	0	1	0	1	1	0	0	29	37
LEVEL 4	36.9 m <sup>2</sup>	0.0 m <sup>2</sup>	26	0	1	0	1	1	0	0	29	37
LEVEL 5	36.8 m <sup>2</sup>	0.0 m <sup>2</sup>	26	0	1	0	1	1	0	0	29	37
LEVEL 6	36.9 m <sup>2</sup>	0.0 m <sup>2</sup>	25	0	1	0	1	1	0	0	28	36
LEVEL 7	36.8 m <sup>2</sup>	0.0 m <sup>2</sup>	25	0	1	0	1	1	0	0	28	36
LEVEL 8	36.9 m <sup>2</sup>	0.0 m <sup>2</sup>	25	0	1	0	1	1	0	0	28	36
LEVEL 9	36.8 m <sup>2</sup>	0.0 m <sup>2</sup>	25	0	1	0	1	1	0	0	28	36
LEVEL 10	36.9 m <sup>2</sup>	0.0 m <sup>2</sup>	25	0	1	0	1	1	0	0	28	36
LEVEL 11	36.8 m <sup>2</sup>	0.0 m <sup>2</sup>	25	0	1	0	1	1	0	0	28	36
LEVEL 12	36.9 m <sup>2</sup>	0.0 m <sup>2</sup>	25	0	1	0	1	1	0	0	28	36
LEVEL 13	36.9 m <sup>2</sup>	0.0 m <sup>2</sup>	20	0	1	0	1	2	2	0	26	48
LEVEL 14	0.0 m <sup>2</sup>	0.0 m <sup>2</sup>	0	0	0	0	0	0	0	0	0	0
	1263.4 m²	37.5 m <sup>2</sup>	325	0	13	1	13	14	2	0	368	488

COMMUNAL AREAS INCLUDE:

BASEMENT MEZZANINE & GROUND LEVELS: FOYER / WAITING

CINEMA GAMES LOUNGE

LAUNDRY **AMENITIES** 

QUIET STUDY & PODS

CASUAL STUDY & MEDIA **KITCHEN** 

DINING MAIL ROOM

LOUNGE 1

LOUNGE 2

LEVELS 1 - 13:

COMMUNAL LOUNGE (LEVELS 1, 3, 5, 7, 9, 11)

COMMUNAL KITCHEN / DINING (LEVELS 2, 4, 6, 8, 10, 12) COMMUNAL LOUNGE / KITCHEN / DINING LEVEL 13


# CARPARK COUNT

LEVEL	VISITOR	CAR SHARE	STAFF	RESIDENT STACKER	CARPARKS TOTAL	MOTORBIKE / SCOOTER	BICYCLE
BASEMENT 2	5	5	2	40	52	9	90
BASEMENT 1	12	0	0	0	12	12	0
GROUND	0	0	0	0	0	0	12
	17	5	2	40	64	21	102
	FFECTIVE TOT			EFFECTIVE CAR (CARSHARE RAT			

# **DEVELOPMENT APPLICATION**

09.04.2021 DA SUBMISSION

20.04.2021 DA SUBMISSION RFI RESPONSE BR 24.08.2021 DA SUBMISSION RFI RESPONSE KW 14.04.2022 DA SUBMISSION RFI RESPONSE BR

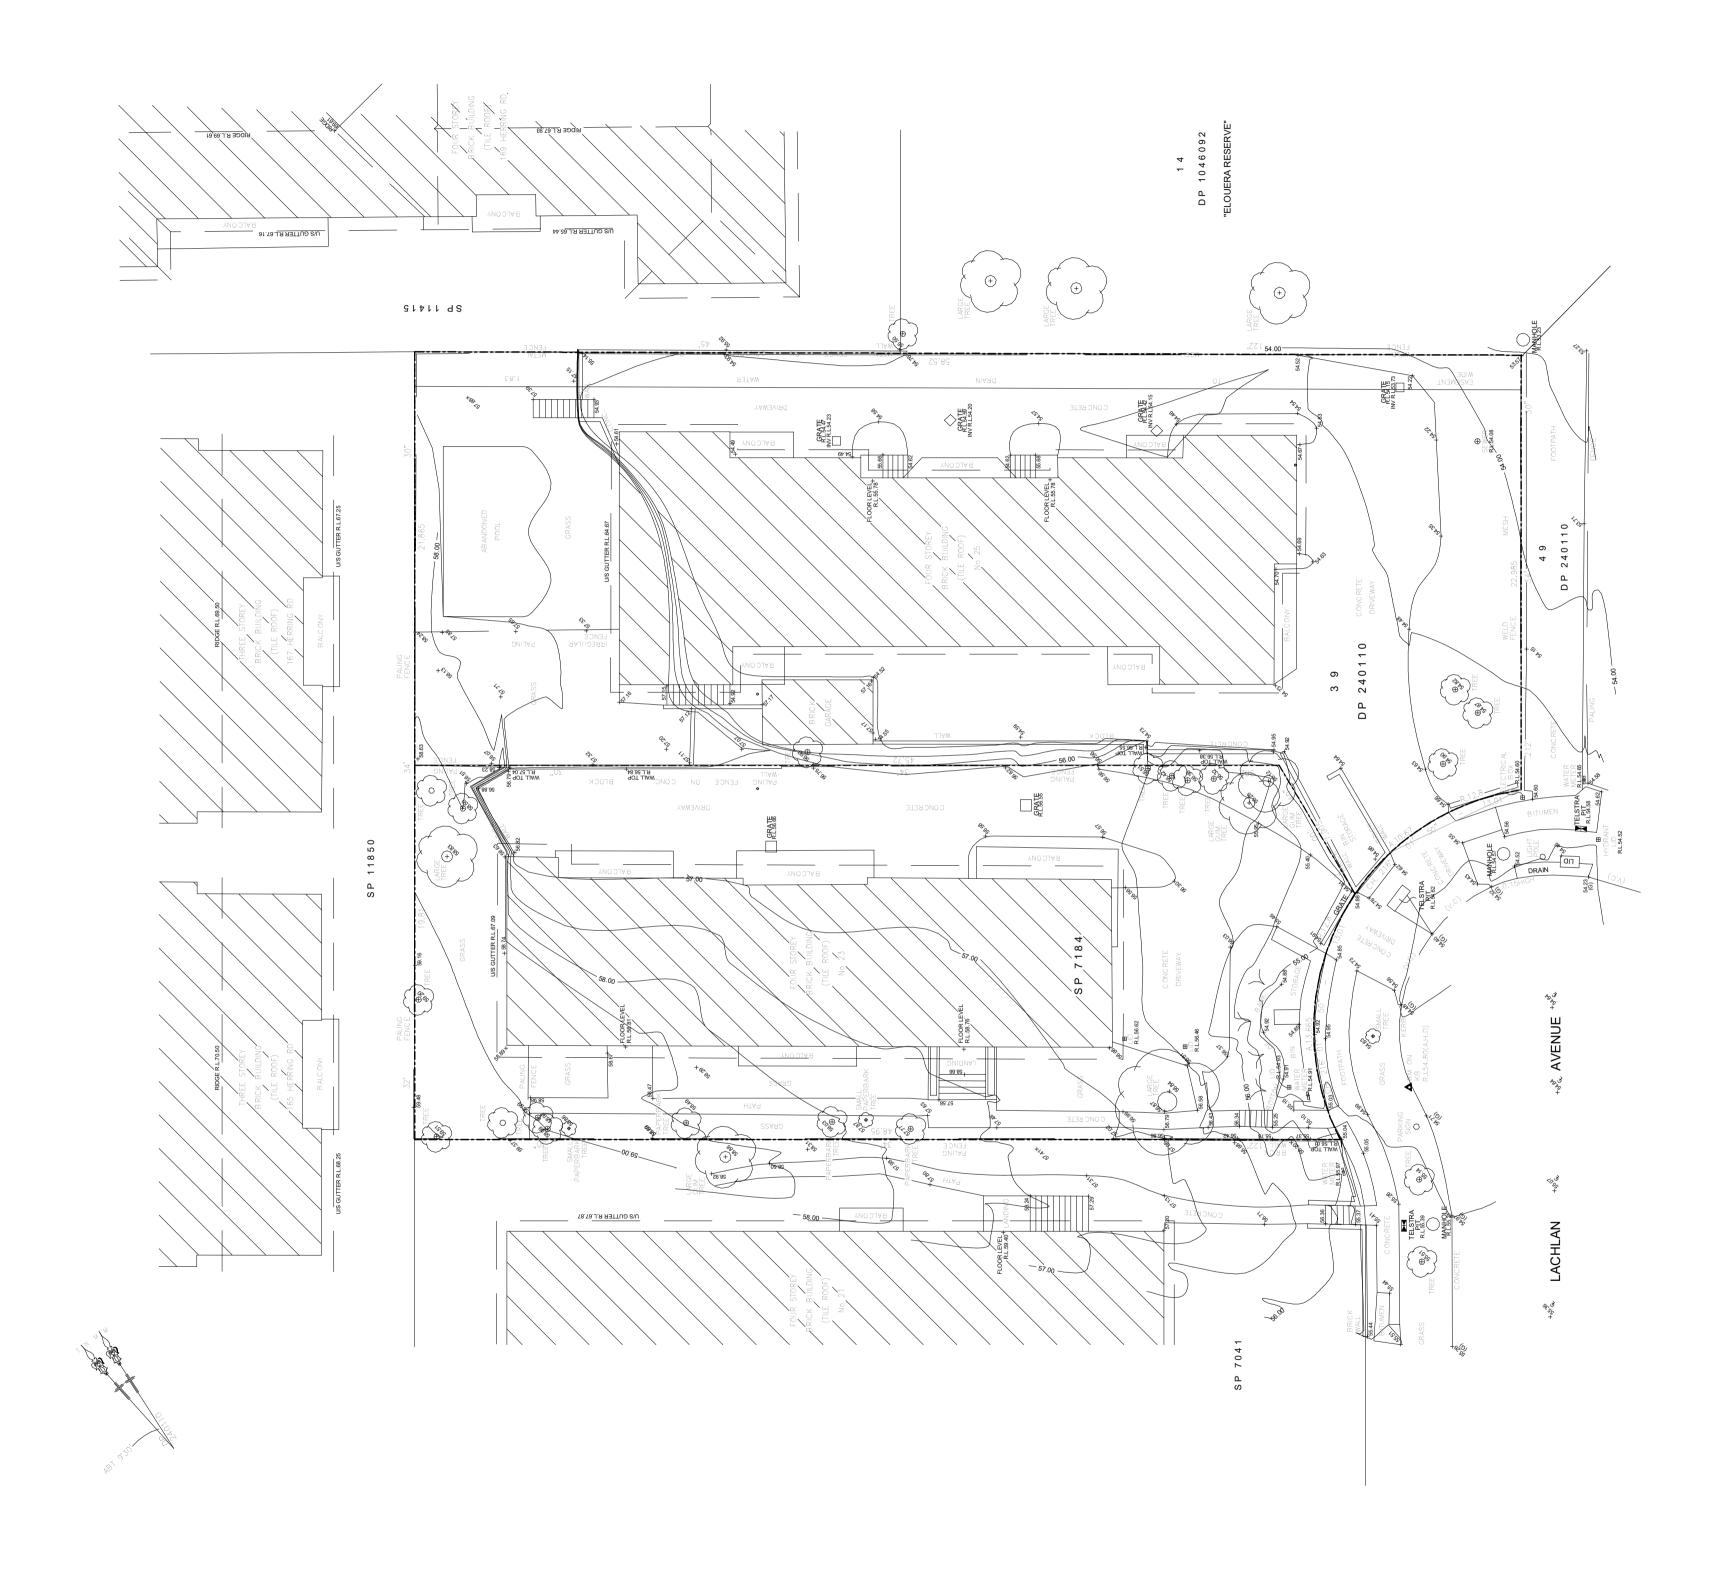

Revisions A 09.04.2021 DA SUBMISSION

LACHLAN AVENUE


23-25 LACHLAN AVENUE, MACQUARIE PARK

SITE SURVEY

219099 Date 09.04.2021 KW Scale: @ A1 1: 200 TP00.02 Revision A



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#### **Demolition Notes**

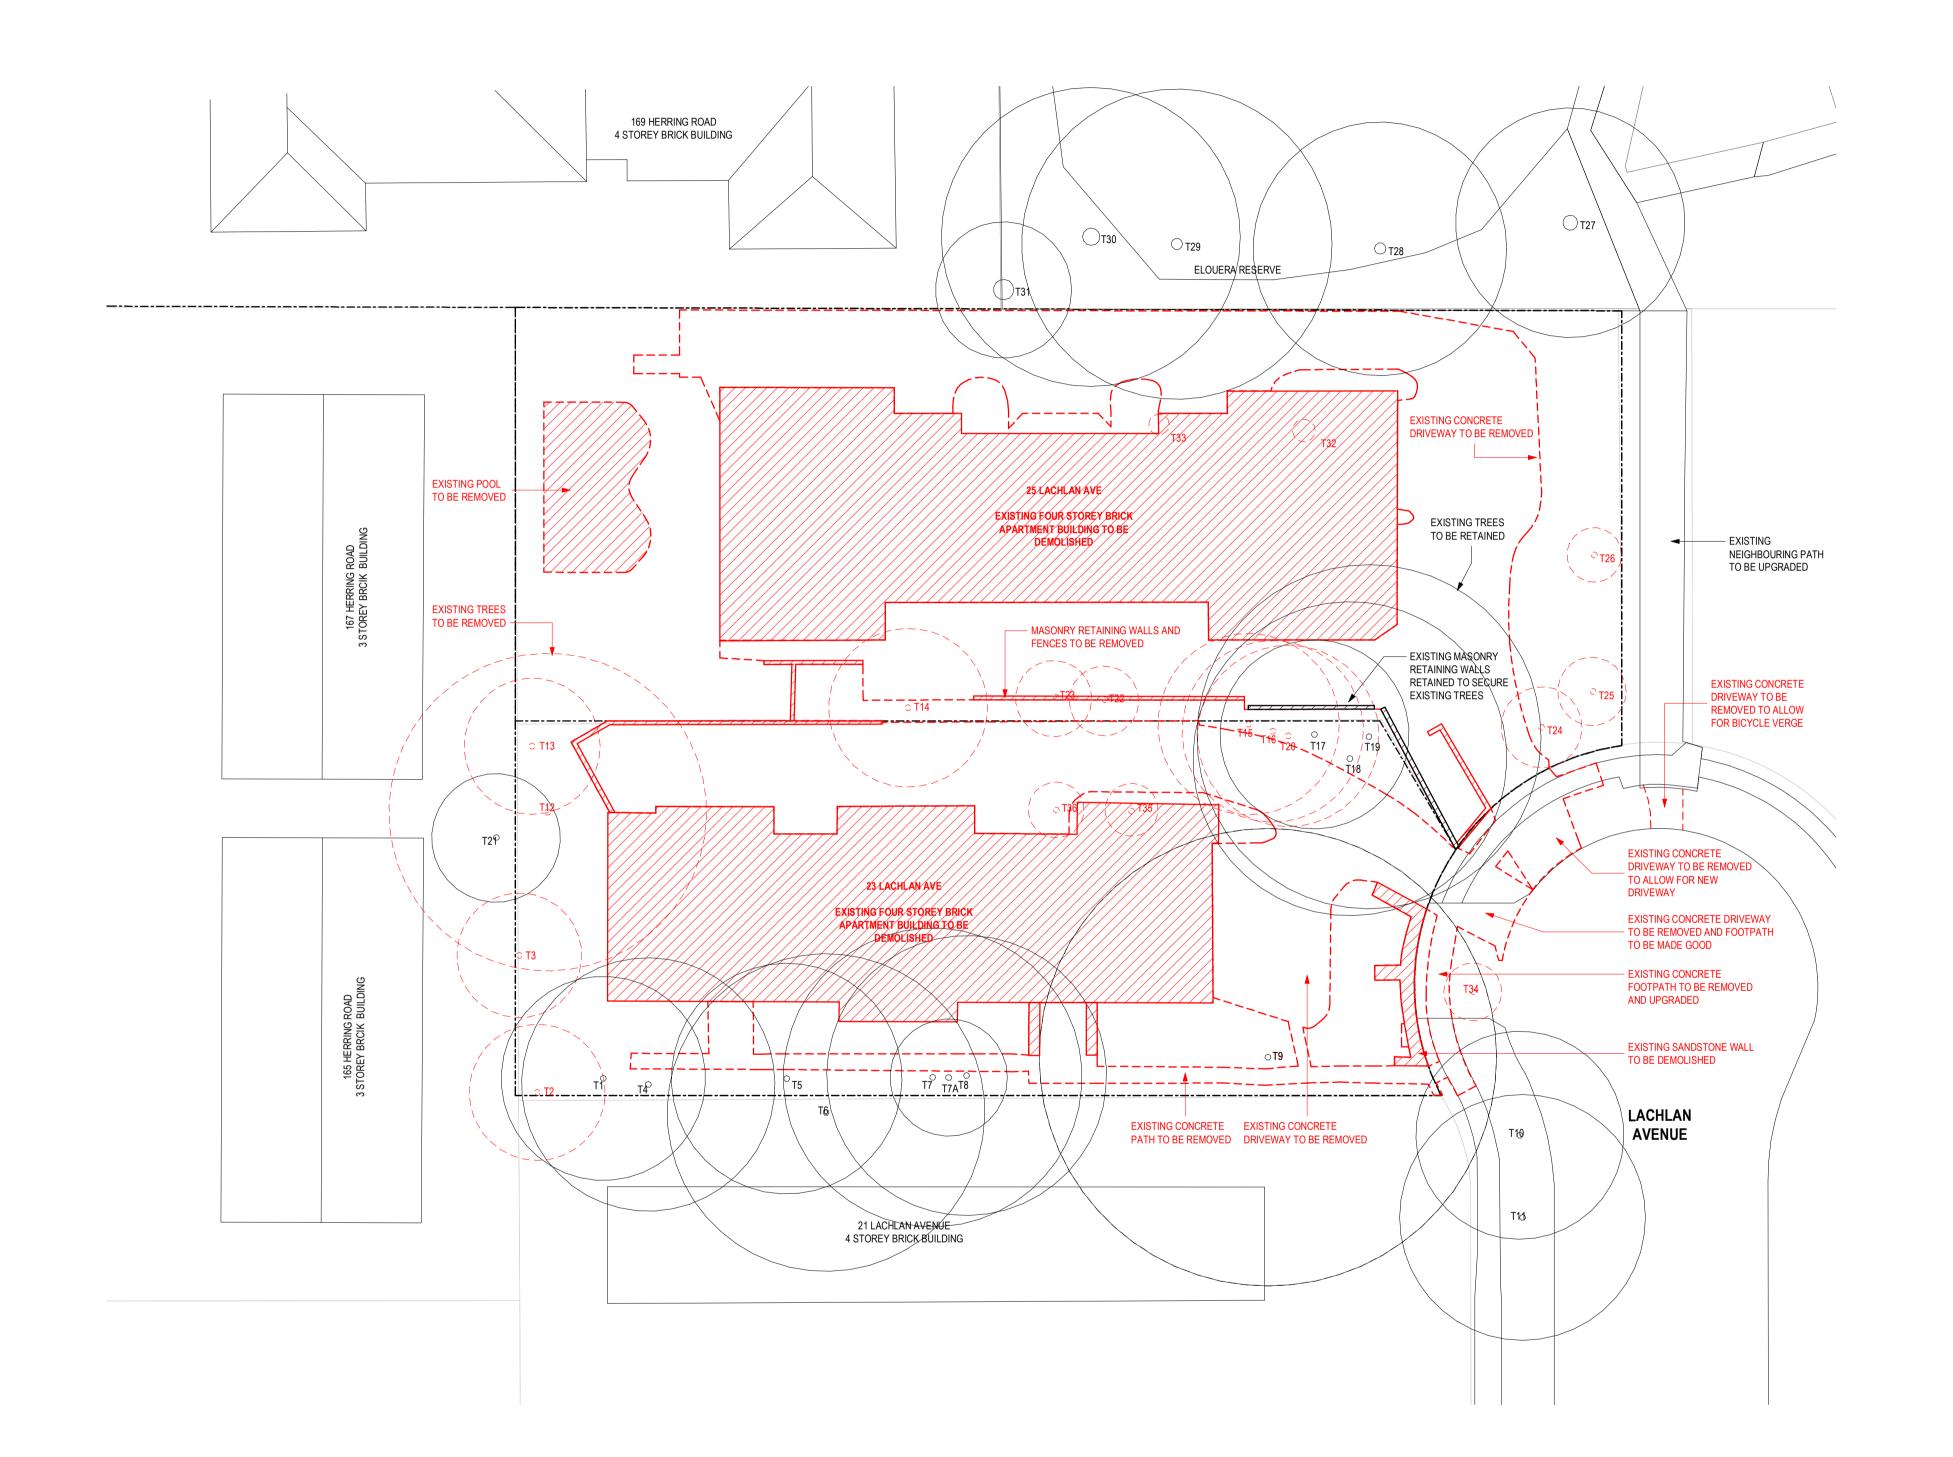Contractor to confirm existing conditions on site.

Contractor to demolish existing structure/remove all materials. Cut and seal services as required in accordance with local authority requirements and A.S. codes for that trade U.N.O

Protection of works as required by local authorities

Cleaning of site to EPA requirements by contractor

Contractor to allow for complete demolition & removal of all asbestos products. All asbestos products to be removed & handled as per relevant Australian standards

Extent of demolition work as indicated on this drawing & heritage consultants drawings & specifications, including but not limited to the following: Removal/demolition of all existing floor/slabs & footings,

gutters, downpipes, rainwater heads, cappings, flashing gutter board supports etc. U.N.O Removal/demolition of all existing works including but not

external and internal walls, windows, doors, cladding,

limited to external steps, paths, carparks, planters & landscaping, gates, fences, garden walls, retaining walls, bollards, light blades signs, columns etc. U.N.O Removal/demolition of all existing fixtures and fittings

including but not limited to lights, taps, basins, wcs etc.

Disconnection & removal of existing services to be undertaken by appropriate contractors Contractor to make good damage to adjoining buildings. pavement, laneways, roads, fences, kerbs, channels, services, street furniture, carspace markings etc. (ie. Any

adjoining objects/materials not within site boundary) resulting from demolition works. All repairs to authority requirements or to condition prior to demolition. Contractors are responsible for relocation and co-ordination of road carparking markings, ticket machines

Precautionary measures to be undertaken as described in AS.2601-2001. A "hazardous substances management plan" is to be implemented before and during demolition if the preliminary investigation of the building identifies any hazardous materials contained therein. These materials will be removed as per the guidelines of the responsible authority and clearance certificate obtained before demolition commences

Safety fencing Security fences shall be provided to the street boundary of the demolition site and any additional precautionary measures, taken as may be necessary to prevent unauthorised entry to the site, where the demolition site adjoins a public thoroughfare the common boundary between them shall be fenced for its full length with a hoarding unless the least horizontal distance between the common boundary and the nearest part of the structure is greater than twice the height of the structure. The fencing shall be the equivalent of the chain wire as specified in

Notices lettered in accordance with AS.1319 and displaying the words "warning demolition in progress", or similar, shall be fixed to the fencing at appropriate places to warn the public. Provision shall be made for ready access to the site by emergency services personnel in the event of fire or

**Demolition work** of their construction. The order of demolition for buildings shall be progressive, storey by storey, having proper regard to the type of construction. No part of any structure shall be left unsupported or unattended in such a condition that it may collapse or become dangerous. Precautions shall be taken to ensure that the stability of all parts of the structure, and the safety of persons on and outside the site, will be maintained in the event of sudden and severe weather changes.

Walls on the boundaries are to be demolished in a safe and workmanship like manner. Walls shall not be laterally loaded by accumulated debris or rubble, to the extent that they are in danger of collapse, allowable loading of the suspended floors shall be determined by an independent structural engineer.

Dust control The techniques adopted for stripping out and for demolition shall minimise the release of dust into the atmosphere. Before the commencement of stripping or demolition in an area of a structure, any existing accumulations of dust in that area shall be collected, placed in suitable containers and removed. Selection of an appropriate collection technique, such as vacuuming or hosing down, shall take due account of the nature of the dust and the type of hazard it presents. Dust generated during stripping, or during the breaking down of the building fabric to removable sized pieces, shall be kept damp until it is removed from the site or can be otherwise contained. The use of excess water for this purposed shall be avoided.

Noise control Noise shall be minimised as far as practicable, by the selection of appropriate methods and equipment, and by the use of silencing devices wherever practicable to

1. Attention is drawn to recommendations in AS.2436 2. Hours of operating equipment may be restricted by regulatory authority

Fire services

epa/code requirements.

Where a fire hydrant service or a fire hose reel service is provided in a building, it shall be available at all times during the demolition of the building, so that all remaining storeys except the two uppermost storeys, are serviced. Access to the fire protection services, including any booster fitting, shall be maintained at all times. If a sprinkler system is installed in a building to be demolished, it shall be maintained in an operable condition at each storey below the two uppermost unstripped storeys.

Suitable portable fire extinguishers shall be kept at all times in working area and are not protected by other fire services, and maintained in an operable condition.

Adjoining properties

Safe access to and egress from adjoining buildings shall be maintained at all times for the duration of the demolition work. No demolition activity shall cause damage to or adversely affect the structural integrity of adjoining buildings. The effects of vibration and conversion on adjoining buildings and their occupants shall be minimised by selecting demolition methods and equipment appropriate to the circumstances. Where any surface of an adjoining building is exposed by demolition, the need for weatherproofing the exposed surface shall be investigated and temporary or permanent protection provided as appropriate. Precautions shall be taken to minimise the spreading of mud and debris by vehicles leaving the site.

Openings in existing walls and floors, through which there is a risk of persons falling to lower level, shall be either properly guarded or boarded over and the boarding secured against unauthorised or accidental removal. Precautions shall be taken to prevent glass from falling on any person in or outside the building. Demolished material

shall not be allowed to fall freely outside the structure

unless it is confined within a chute or similar enclosure,

which is clear of obstructions to objects falling freely. Demolished material shall be removed progressively from the site and at any time, shall not be allowed to accumulate to the extent that it presents a hazard to the public or to site

All drawings to be read in conjunction with heritage consultants drawings and specifications

and shoring details

Refer structural engineers drawings for all site protection

**LEGEND** 

TREE TO BE RETAINED

\_\_ \_ \_ TREE TO BE REMOVED

BUILDING/ HARDSTANDS TO BE DEMOLISHED

**DEVELOPMENT APPLICATION** 


09.04.2021 DA SUBMISSION 24.08.2021 DA SUBMISSION RFI RESPONSE KW **LACHLAN AVENUE** 


DEMOLITION PLAN
Project No
219099
Date
24.08.2021
Author
KW
Scale: @ A1
1: 200
Drawing No.
7

23-25 LACHLAN AVENUE, MACQUARIE PARK

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# **PRELIMINARY**

Revisions A 09.04.2021 DA SUBMISSION KW
B 24.08.2021 DA SUBMISSION RFI RESPONSE KW

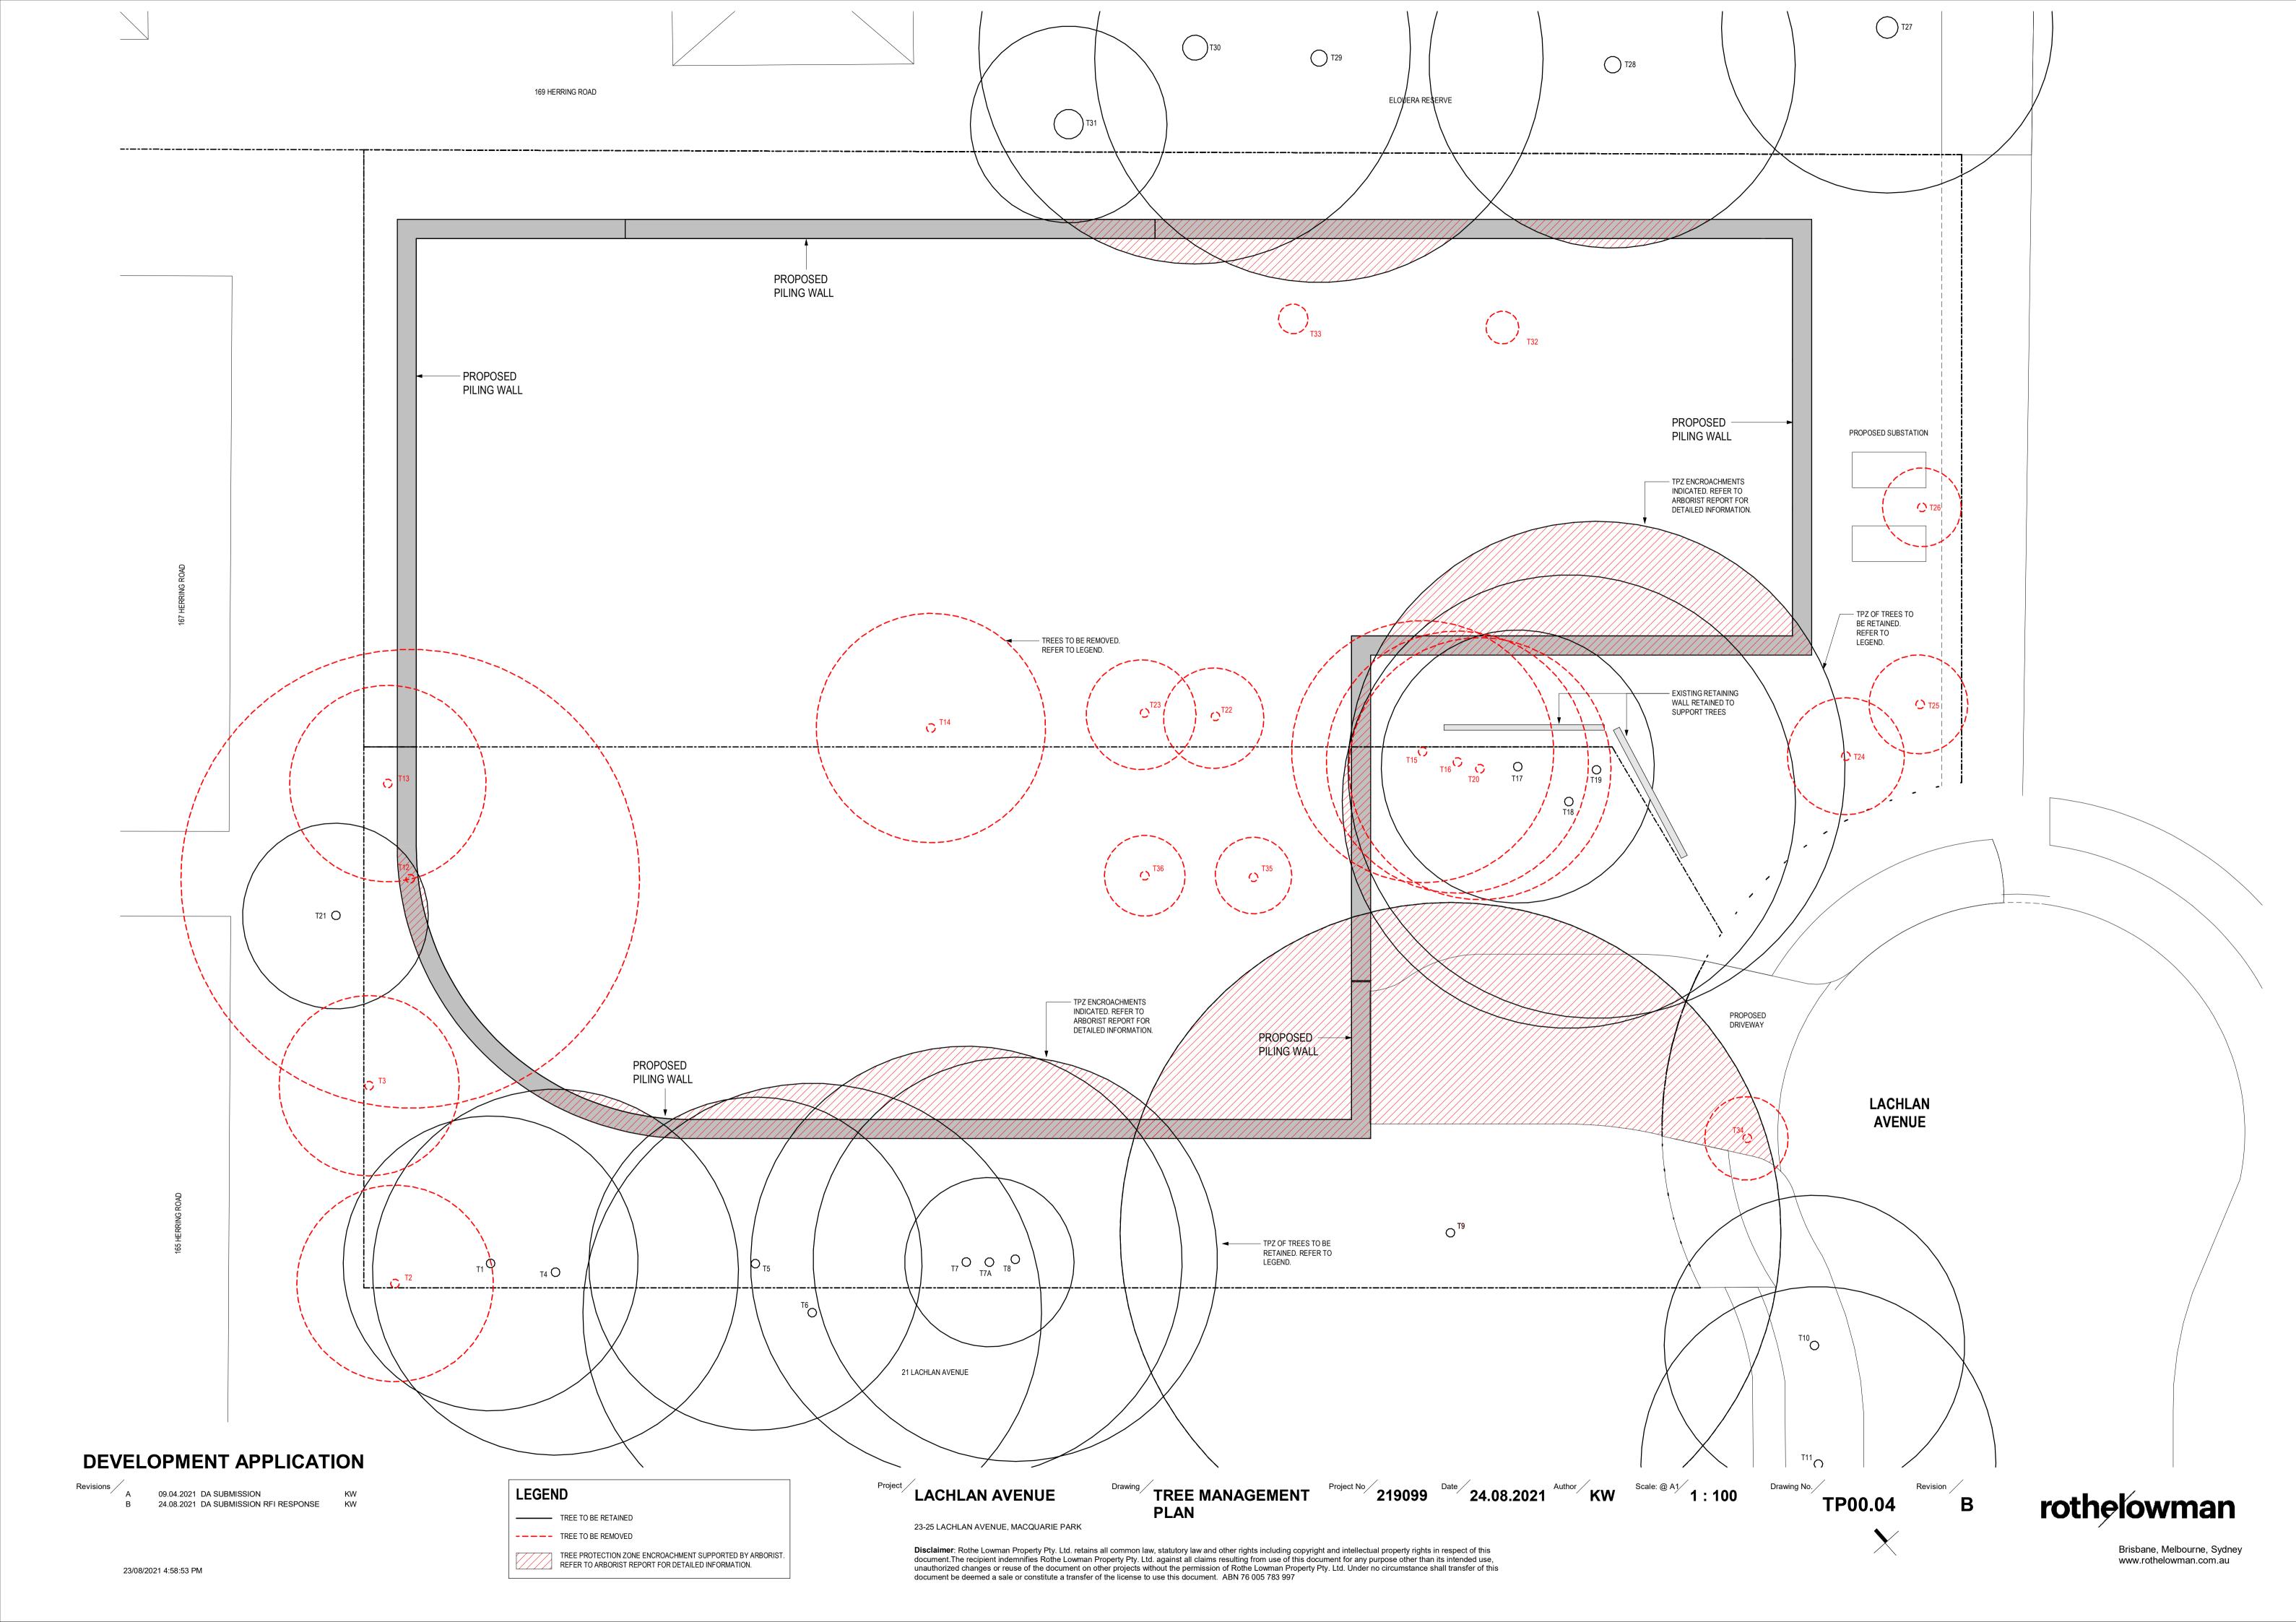LACHLAN AVENUE PROPOSED SITE PLAN Project No 219099 Date 24.08.2021 KW 1:200 TPOOSED SITE PLAN Project No 219099 B 24.08.2021 Author KW 5 Scale: @ A1 1:200 TPOOSED SITE PLAN Project No 219099 B 24.08.2021 Author KW 1:200 TPOOSED SITE PLAN Project No 219099 B 24.08.2021 Author KW 1:200 TPOOSED SITE PLAN Project No 219099 B 24.08.2021 Author KW 1:200 TPOOSED SITE PLAN Project No 219099 B 24.08.2021 Author KW 1:200 TPOOSED SITE PLAN Project No 219099 B 24.08.2021 Author KW 1:200 TPOOSED SITE PLAN Project No 219099 B 24.08.2021 Author KW 1:200 TPOOSED SITE PLAN Project No 219099 B 24.08.2021 Author KW 1:200 TPOOSED SITE PLAN Project NO 219099 B 24.08.2021 Author KW 1:200 TPOOSED SITE PLAN Project No 219099 B 24.08.2021 Author KW 1:200 TPOOSED SITE PLAN Project No 219099 B 24.08.2021 Author KW 1:200 TPOOSED SITE PLAN PROJECT NO 219099 B 24.08.2021 Author KW 1:200 TPOOSED SITE PLAN PROJECT NO 219099 B 24.08.2021 Author KW 1:200 TPOOSED SITE PLAN PROJECT NO 219099 B 24.08.2021 Author KW 1:200 TPOOSED SITE PLAN PROJECT NO 219099 B 24.08.2021 Author KW 1:200 TPOOSED SITE PLAN PROJECT NO 219099 B 24.08.2021 Author KW 1:200 TPOOSED SITE PLAN PROJECT NO 219099 B 24.08.2021 Author KW 1:200 TPOOSED SITE PLAN PROJECT NO 219099 B 24.08.2021 Author KW 1:200 TPOOSED SITE PLAN PROJECT NO 219099 B 24.08.2021 Author KW 1:200 TPOOSED SITE PLAN PROJECT NO 219099 B 24.08.2021 Author KW 1:200 TPOOSED SITE PLAN PROJECT NO 219099 B 24.08.2021 Author KW 1:200 TPOOSED SITE PLAN PROJECT NO 219099 B 24.08.2021 Author KW 1:200 TPOOSED SITE PLAN PROJECT NO 219099 B 24.08.2021 Author KW 1:200 TPOOSED SITE PLAN PROJECT NO 219099 B 24.08.2021 Author KW 1:200 TPOOSED SITE PLAN PROJECT NO 219099 B 24.08.2021 Author KW 1:200 TPOOSED SITE PLAN PROJECT NO 219099 B 24.08.2021 Author KW 1:200 TPOOSED SITE PLAN PROJECT NO 219099 B 24.08.2021 Author KW 1:200 TPOOSED SITE PLAN PROJECT NO 219099 B 24.08.2021 Author KW 1:200 TPOOSED SITE PLAN PROJECT NO 219099 B 24.08.2021 Author KW 1:200 TPOOSED SITE PLAN PROJECT NO 219099 B 24.08.2021 Author KW 1:200 TPOOS
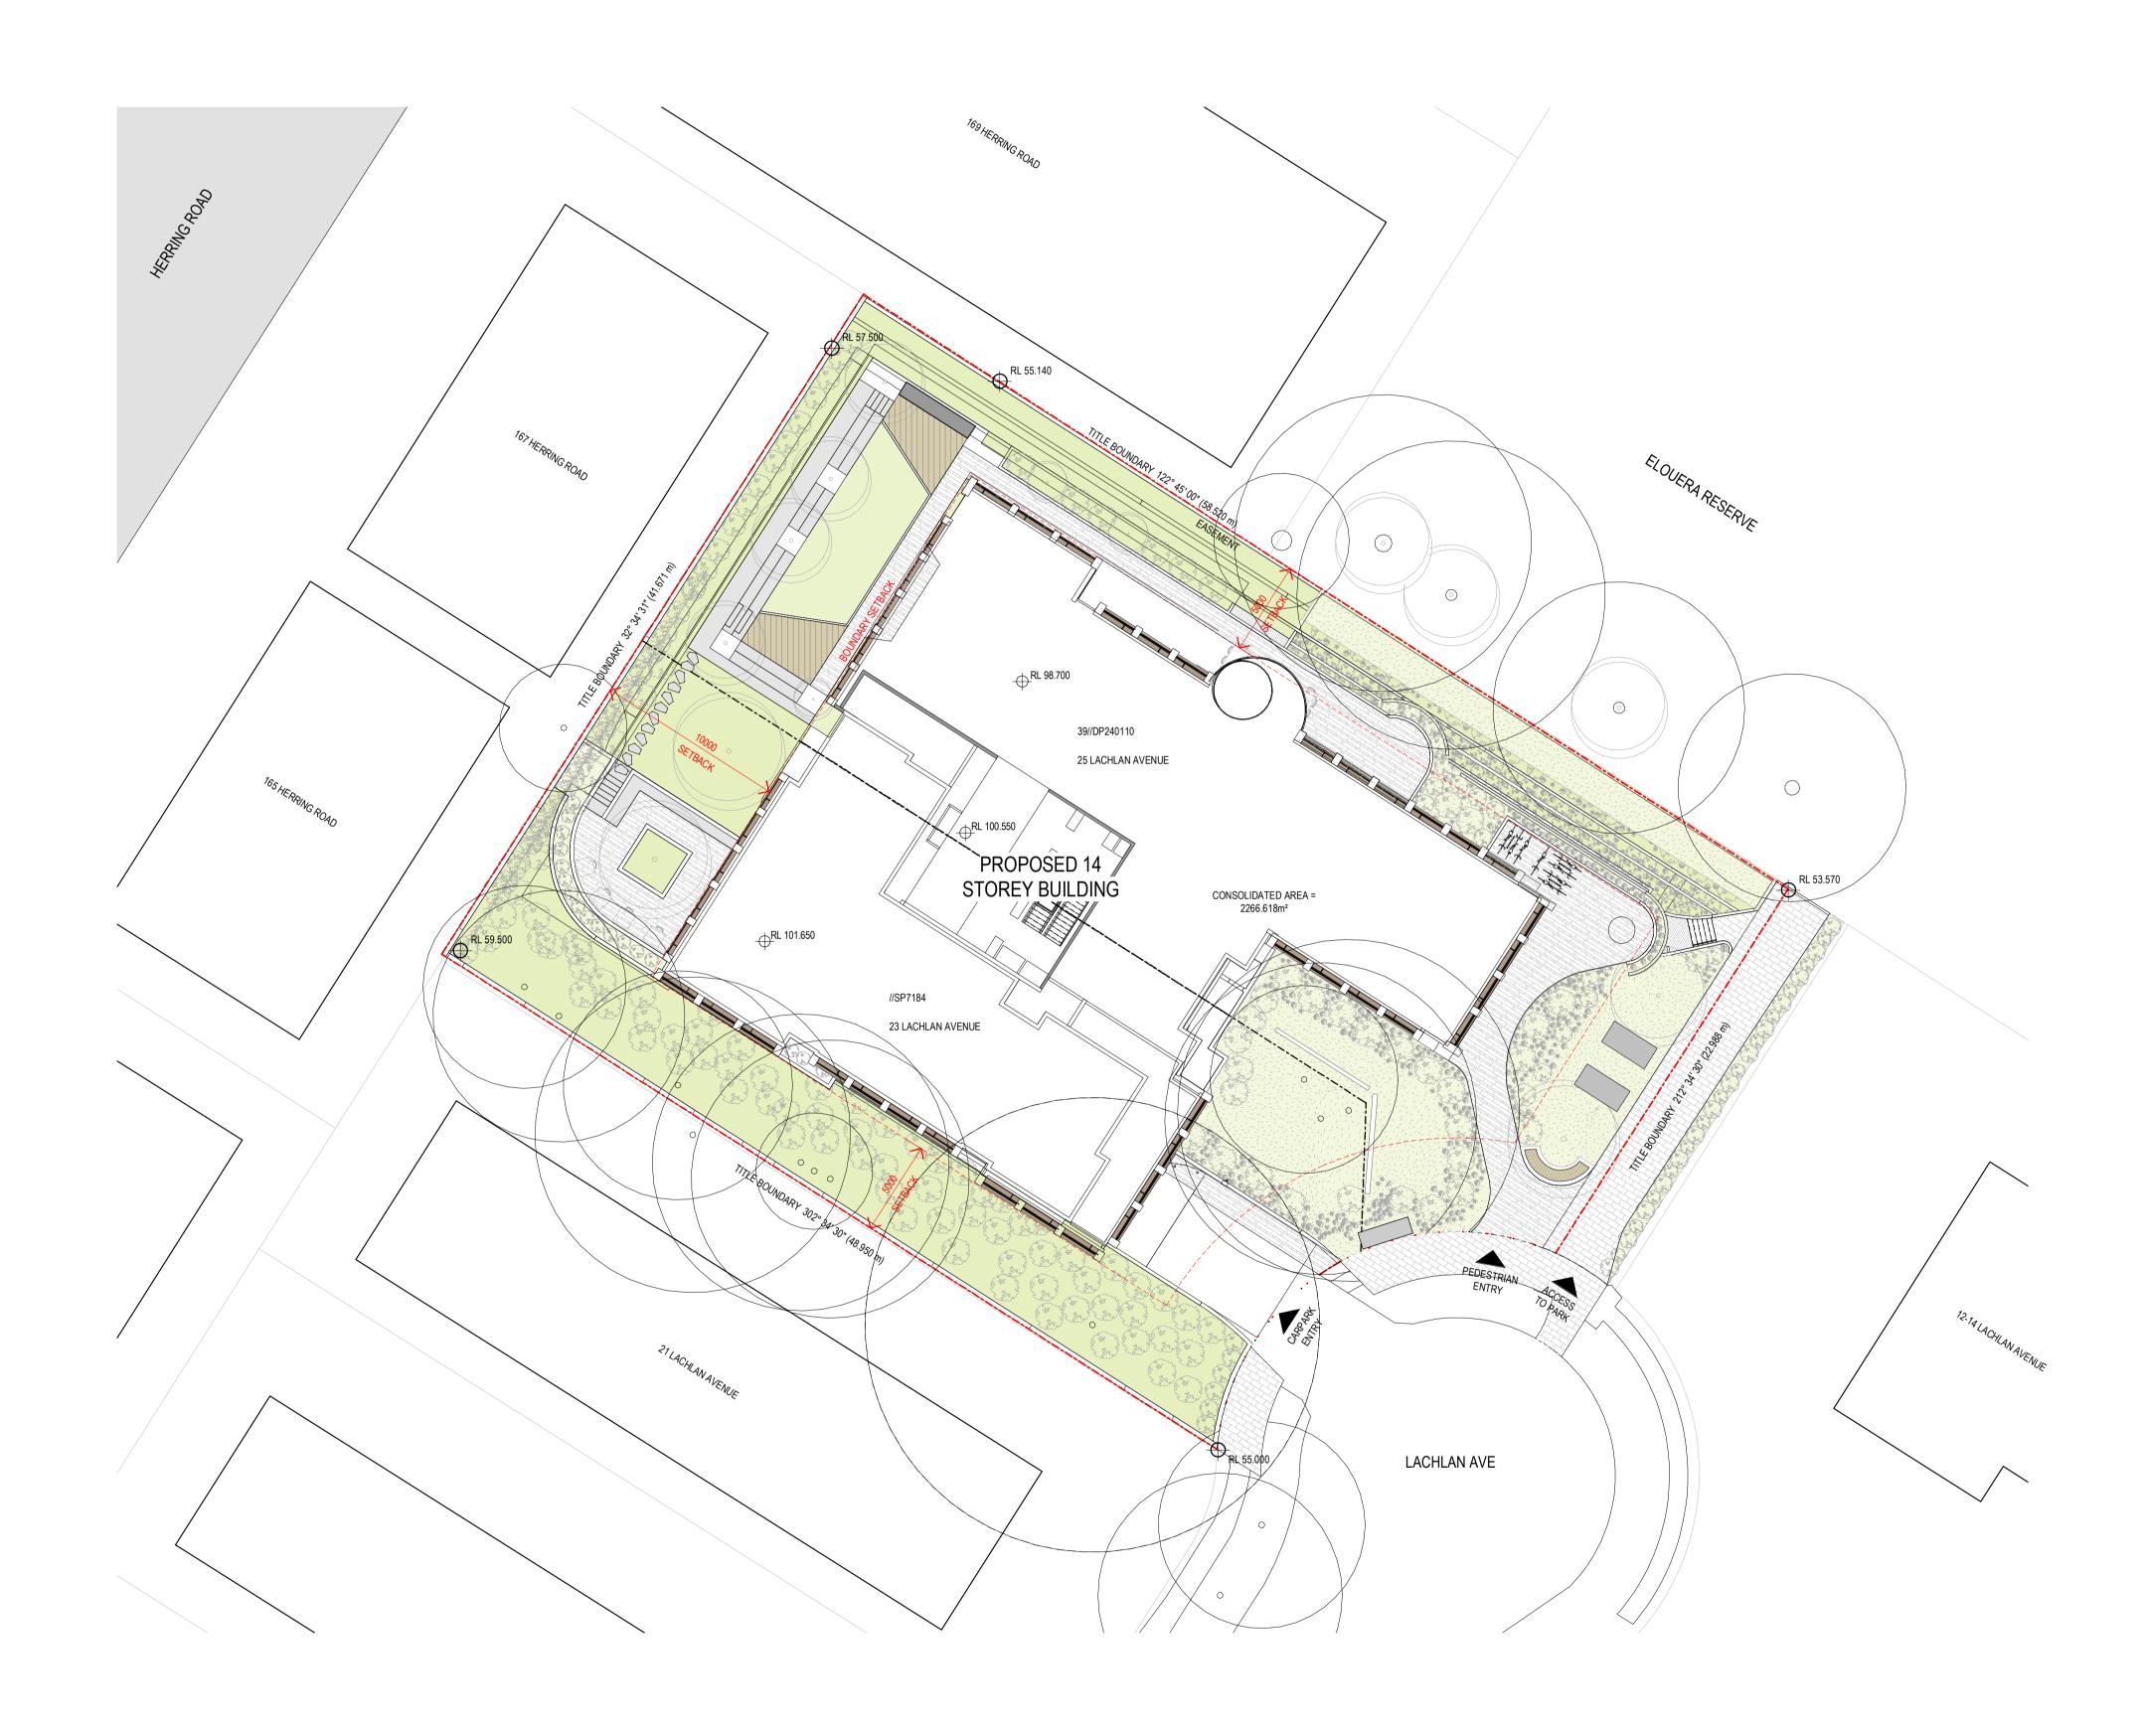
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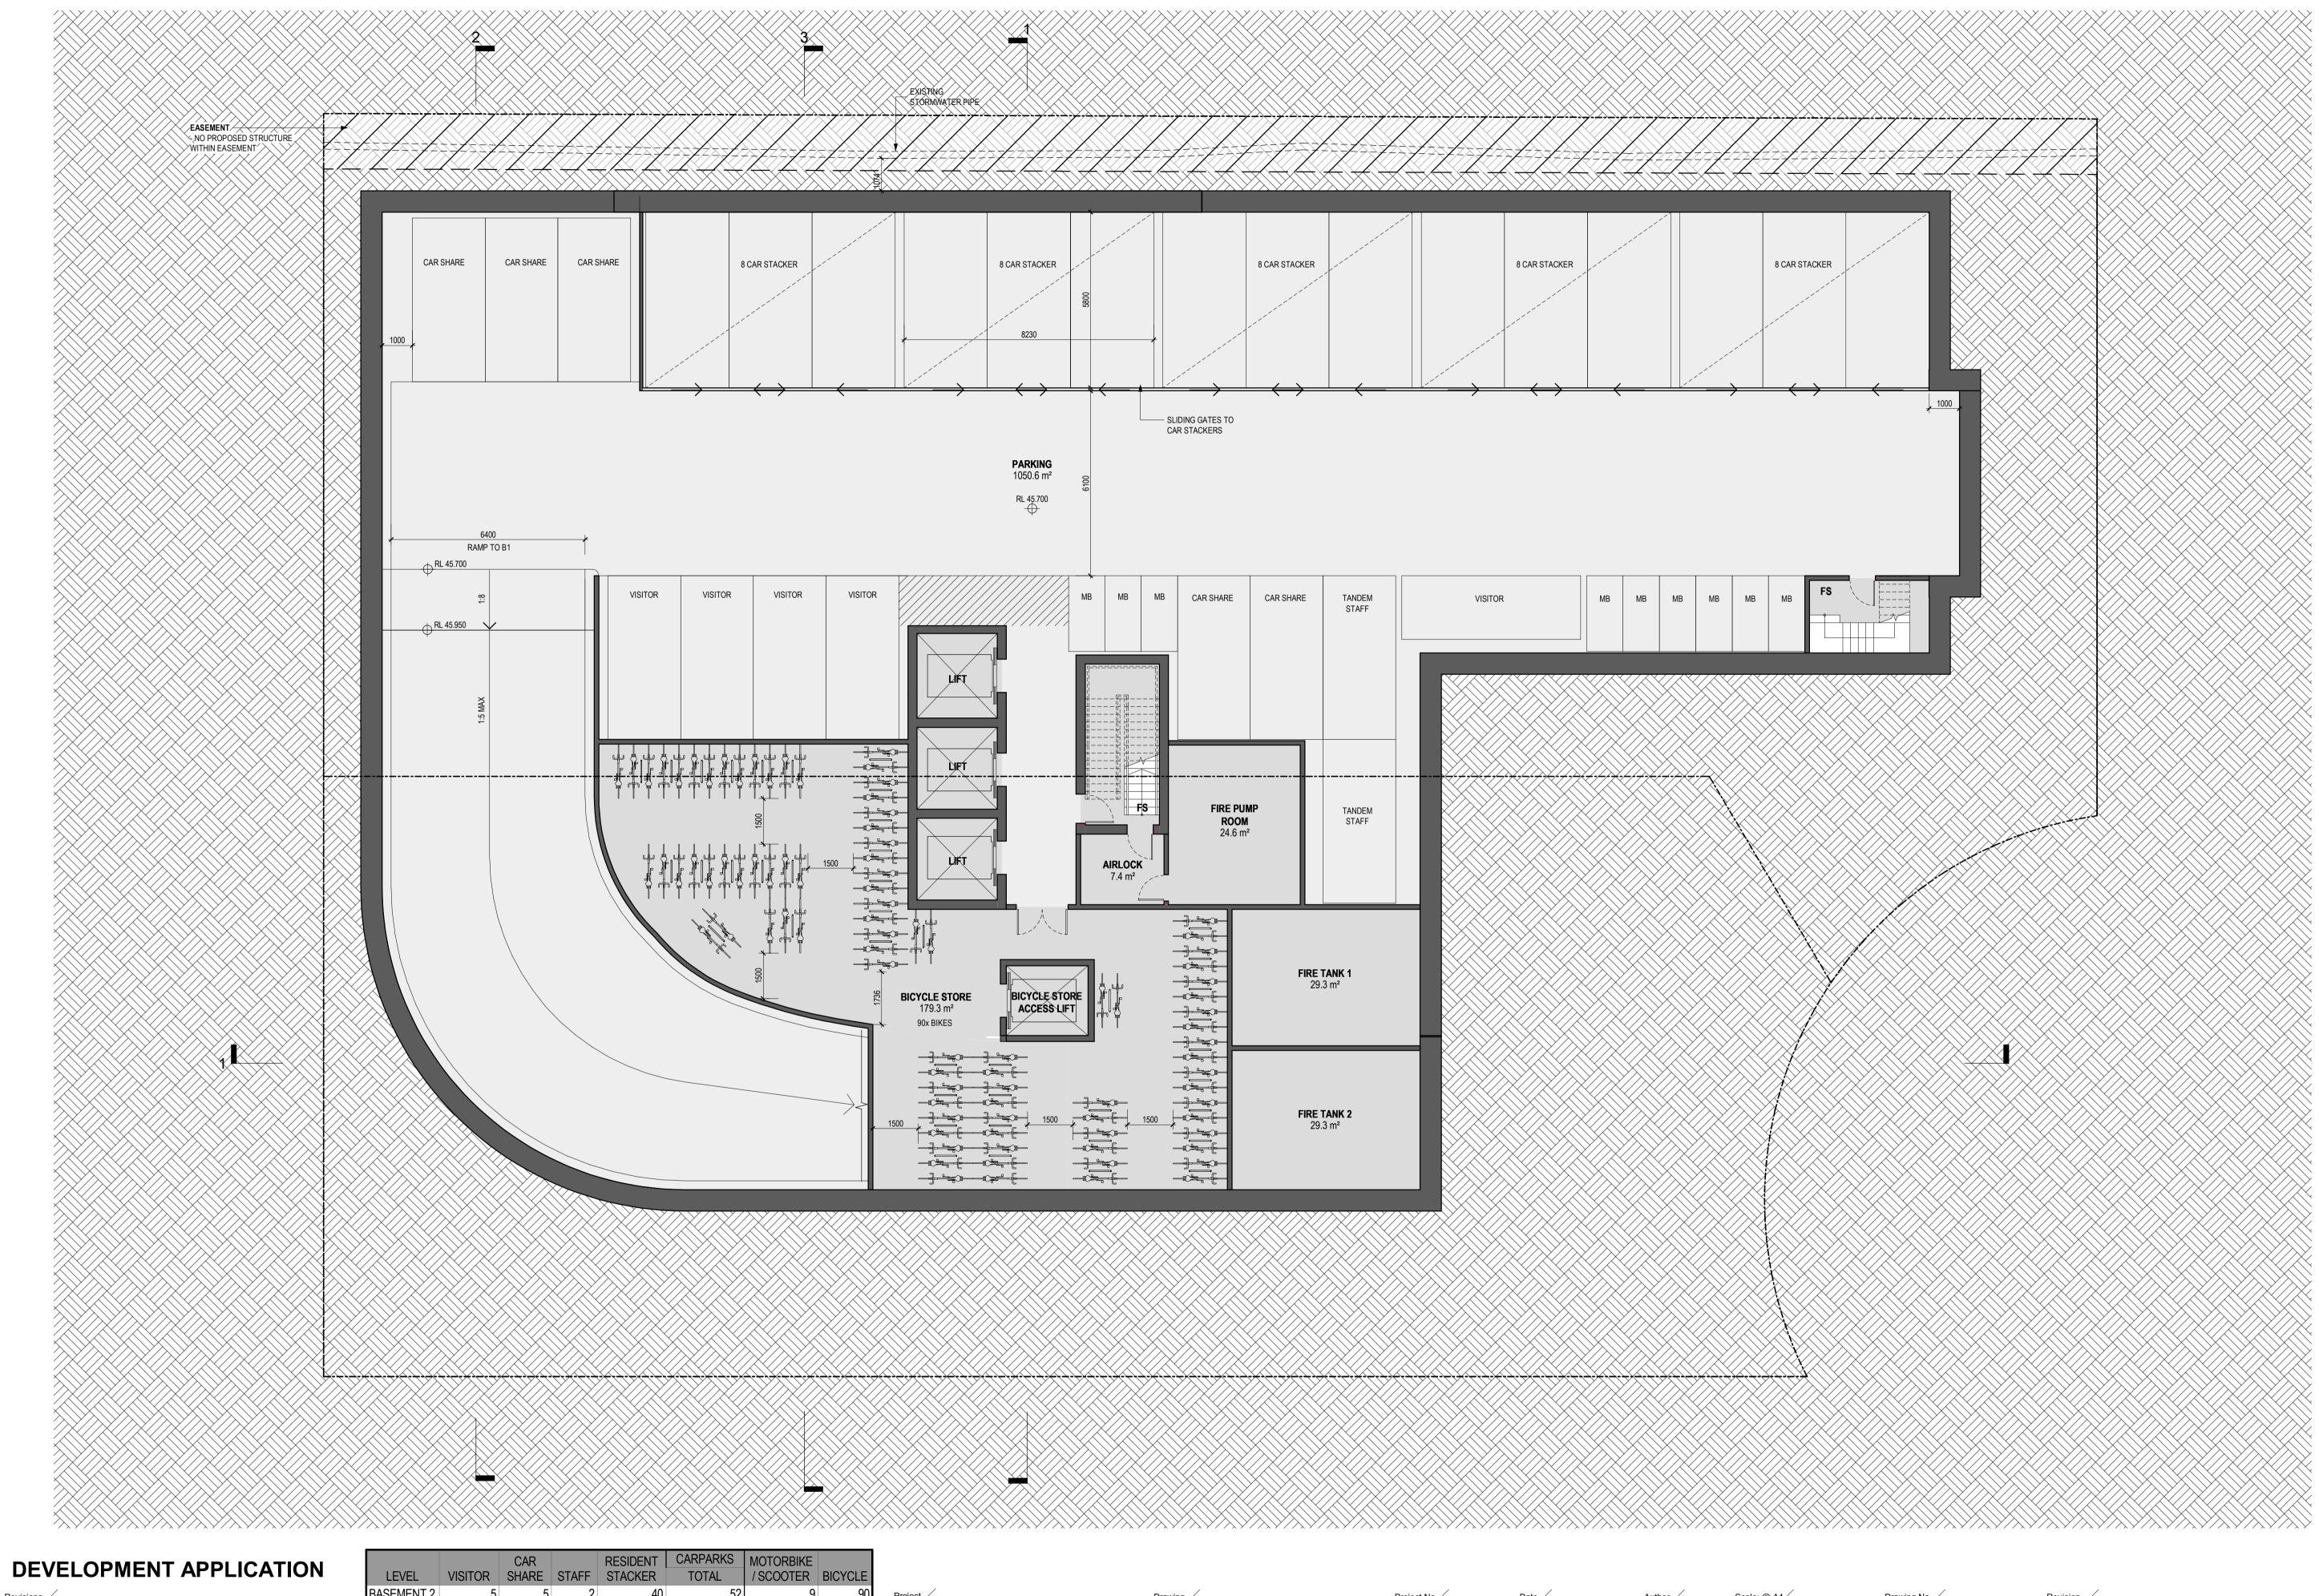
23-25 LACHLAN AVENUE, MACQUARIE PARK

SITE PLAN -**SURROUNDING SITES** 

219099 Date 24.08.2021 KW Scale: @ A1 1: 200 TP00.07



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BASEMENT 2 24.08.2021 DA SUBMISSION RFI RESPONSE KW 14.04.2022 DA SUBMISSION RFI RESPONSE BR BASEMENT 1 GROUND 21 EFFECTIVE TOTAL = 40 — 5x 8 CAR STACKER — (CARSHARE RATIO OF 1:8)

LACHLAN AVENUE


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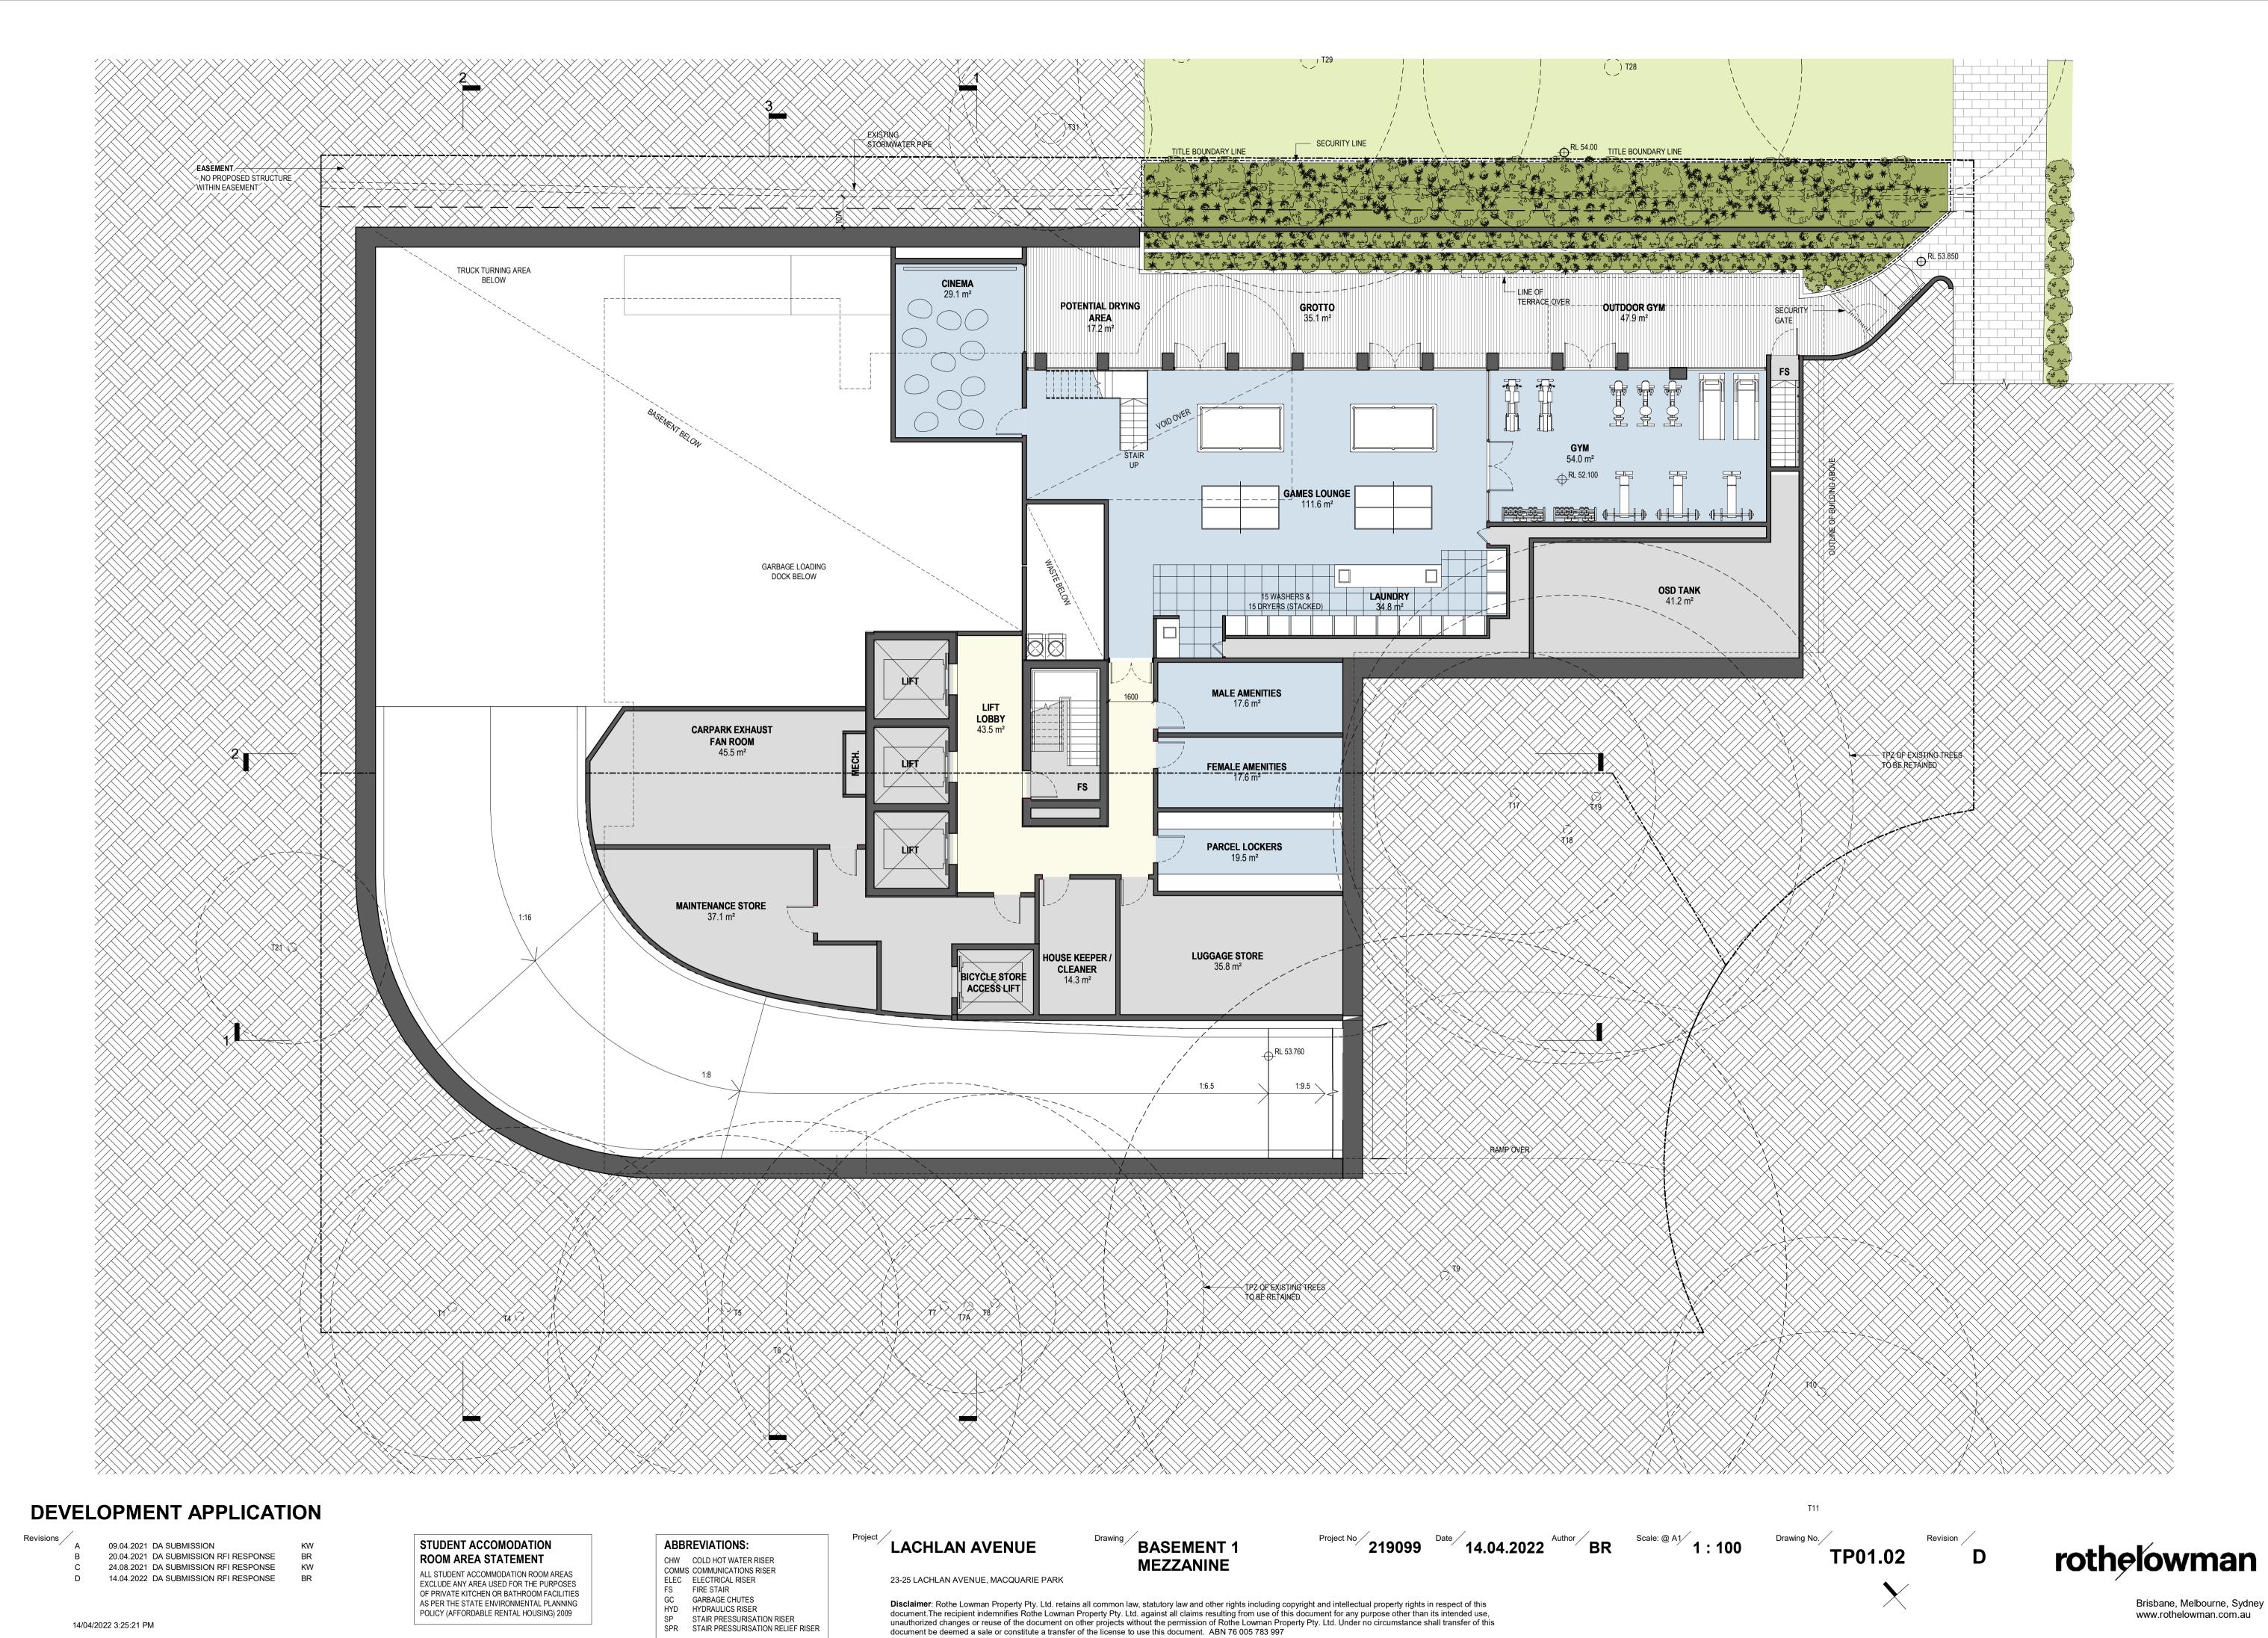
23-25 LACHLAN AVENUE, MACQUARIE PARK

BASEMENT 2

TP01.00

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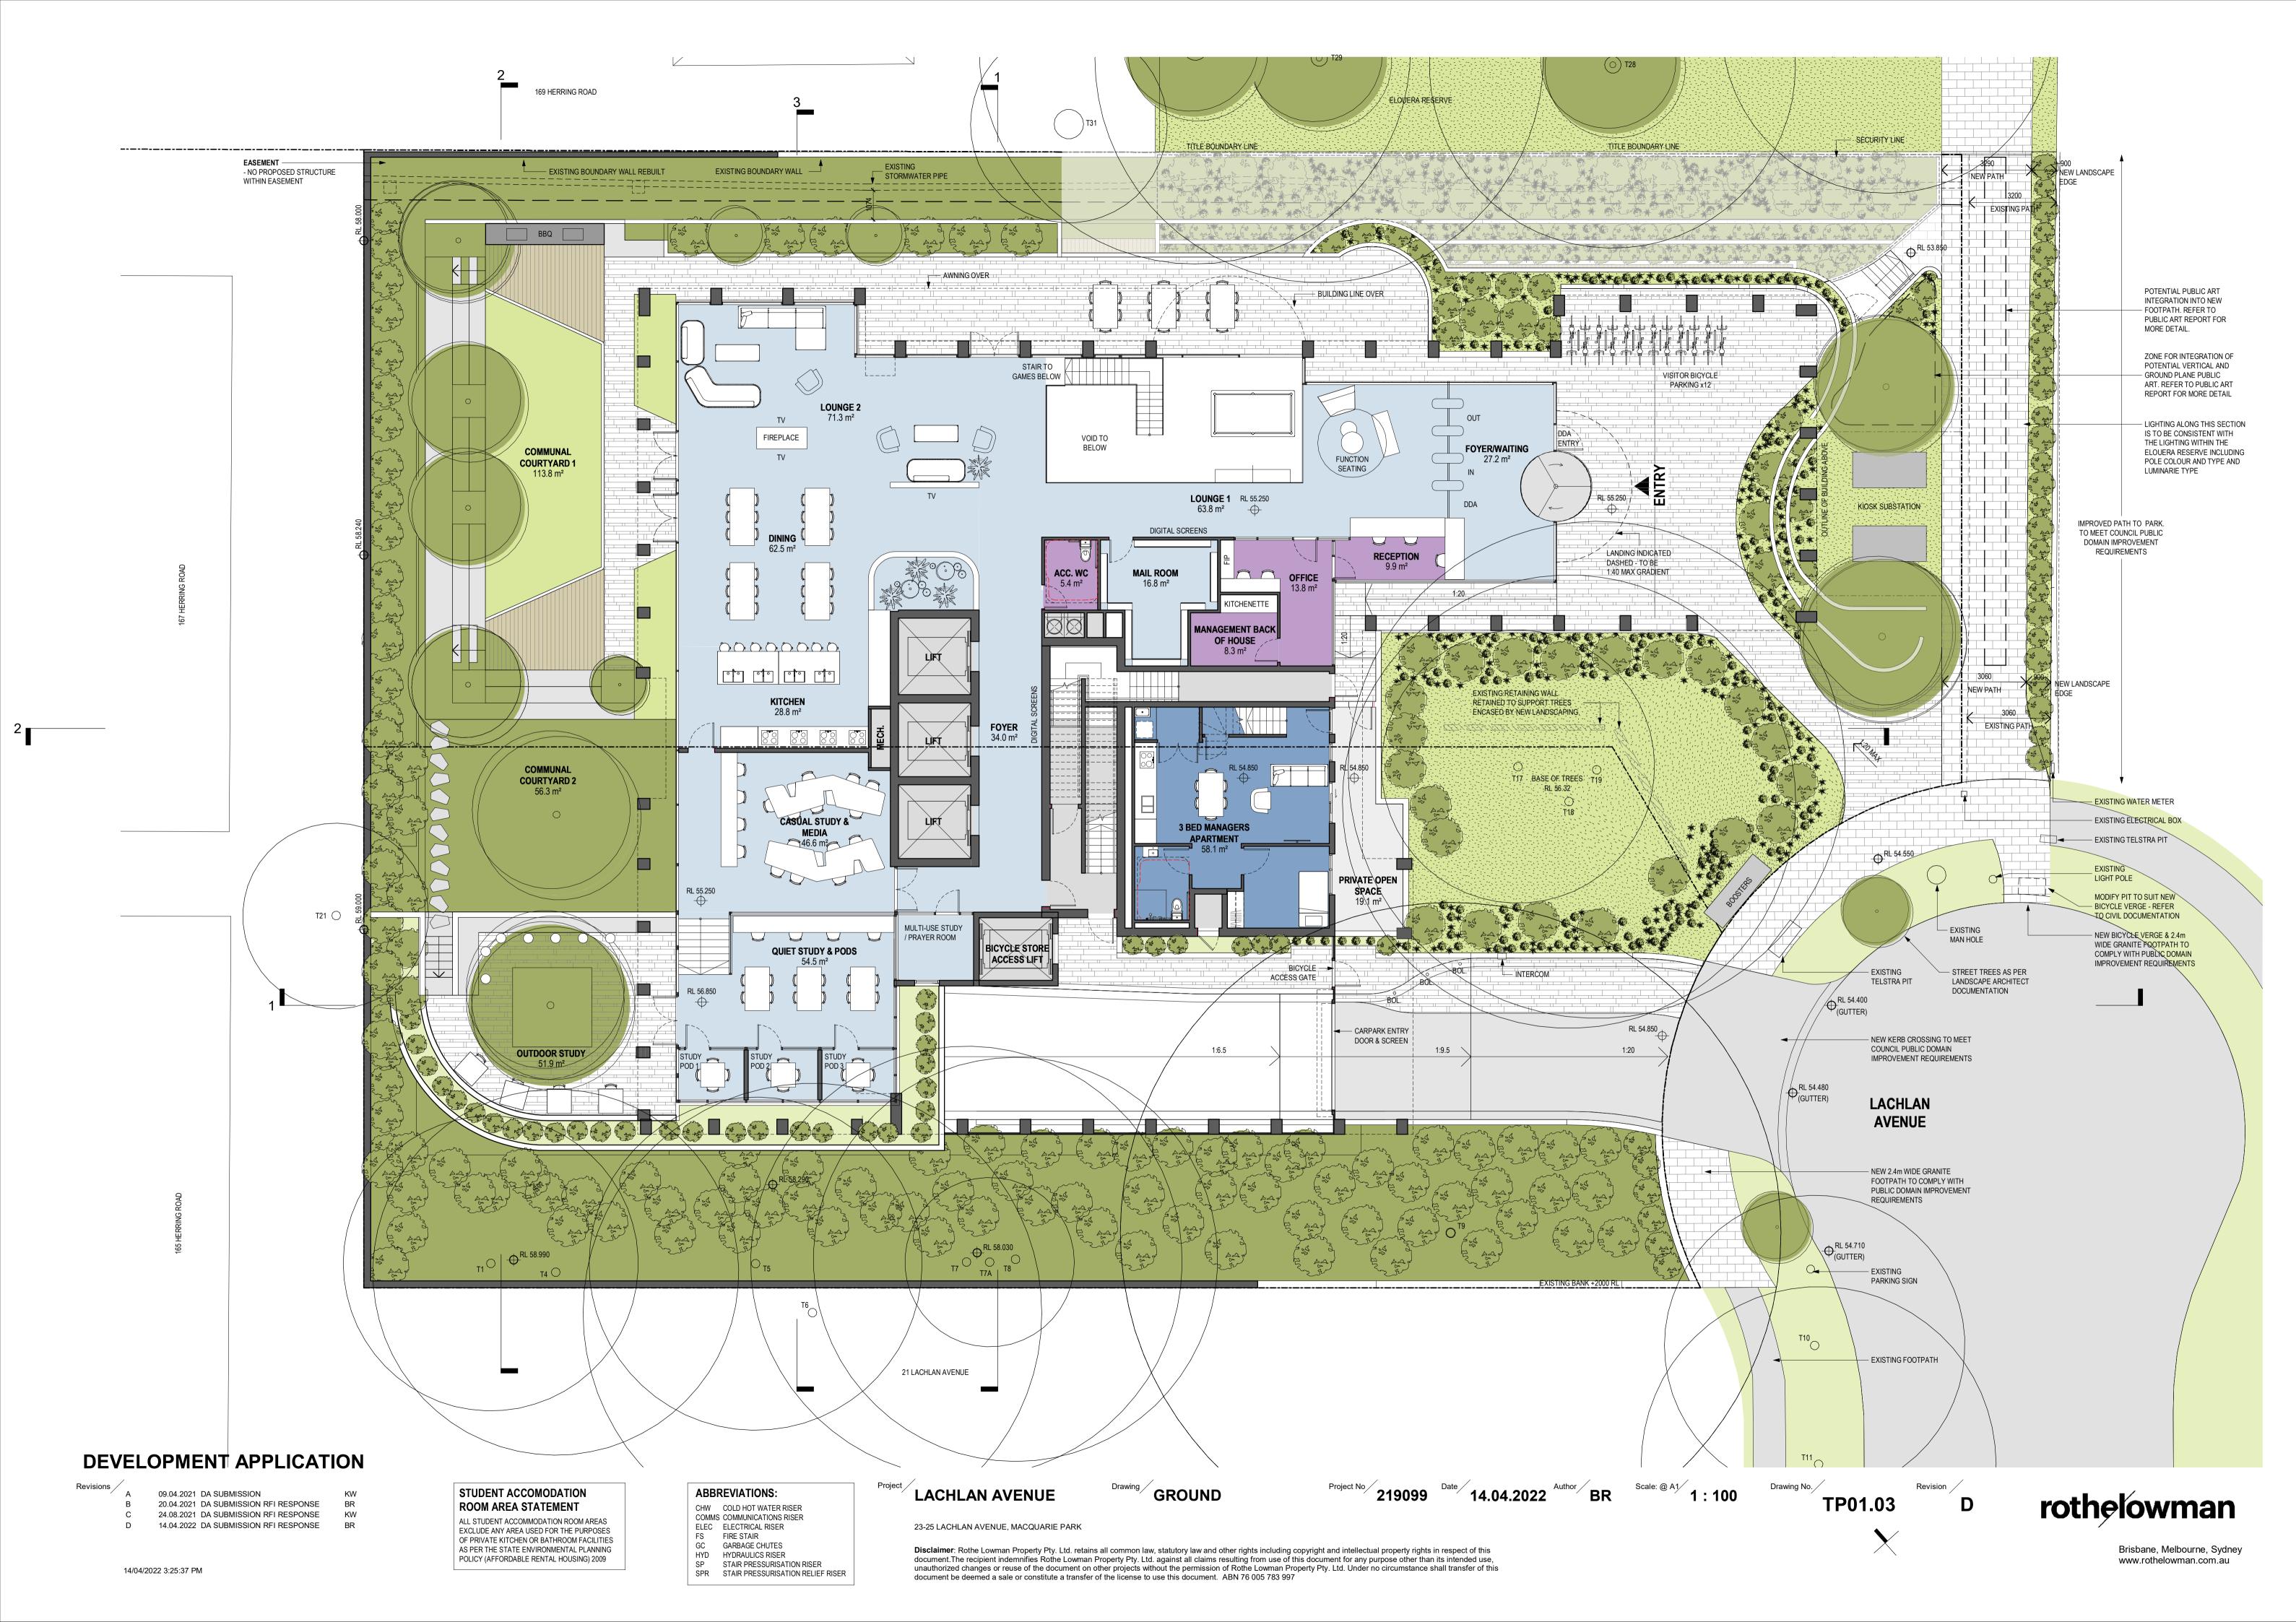


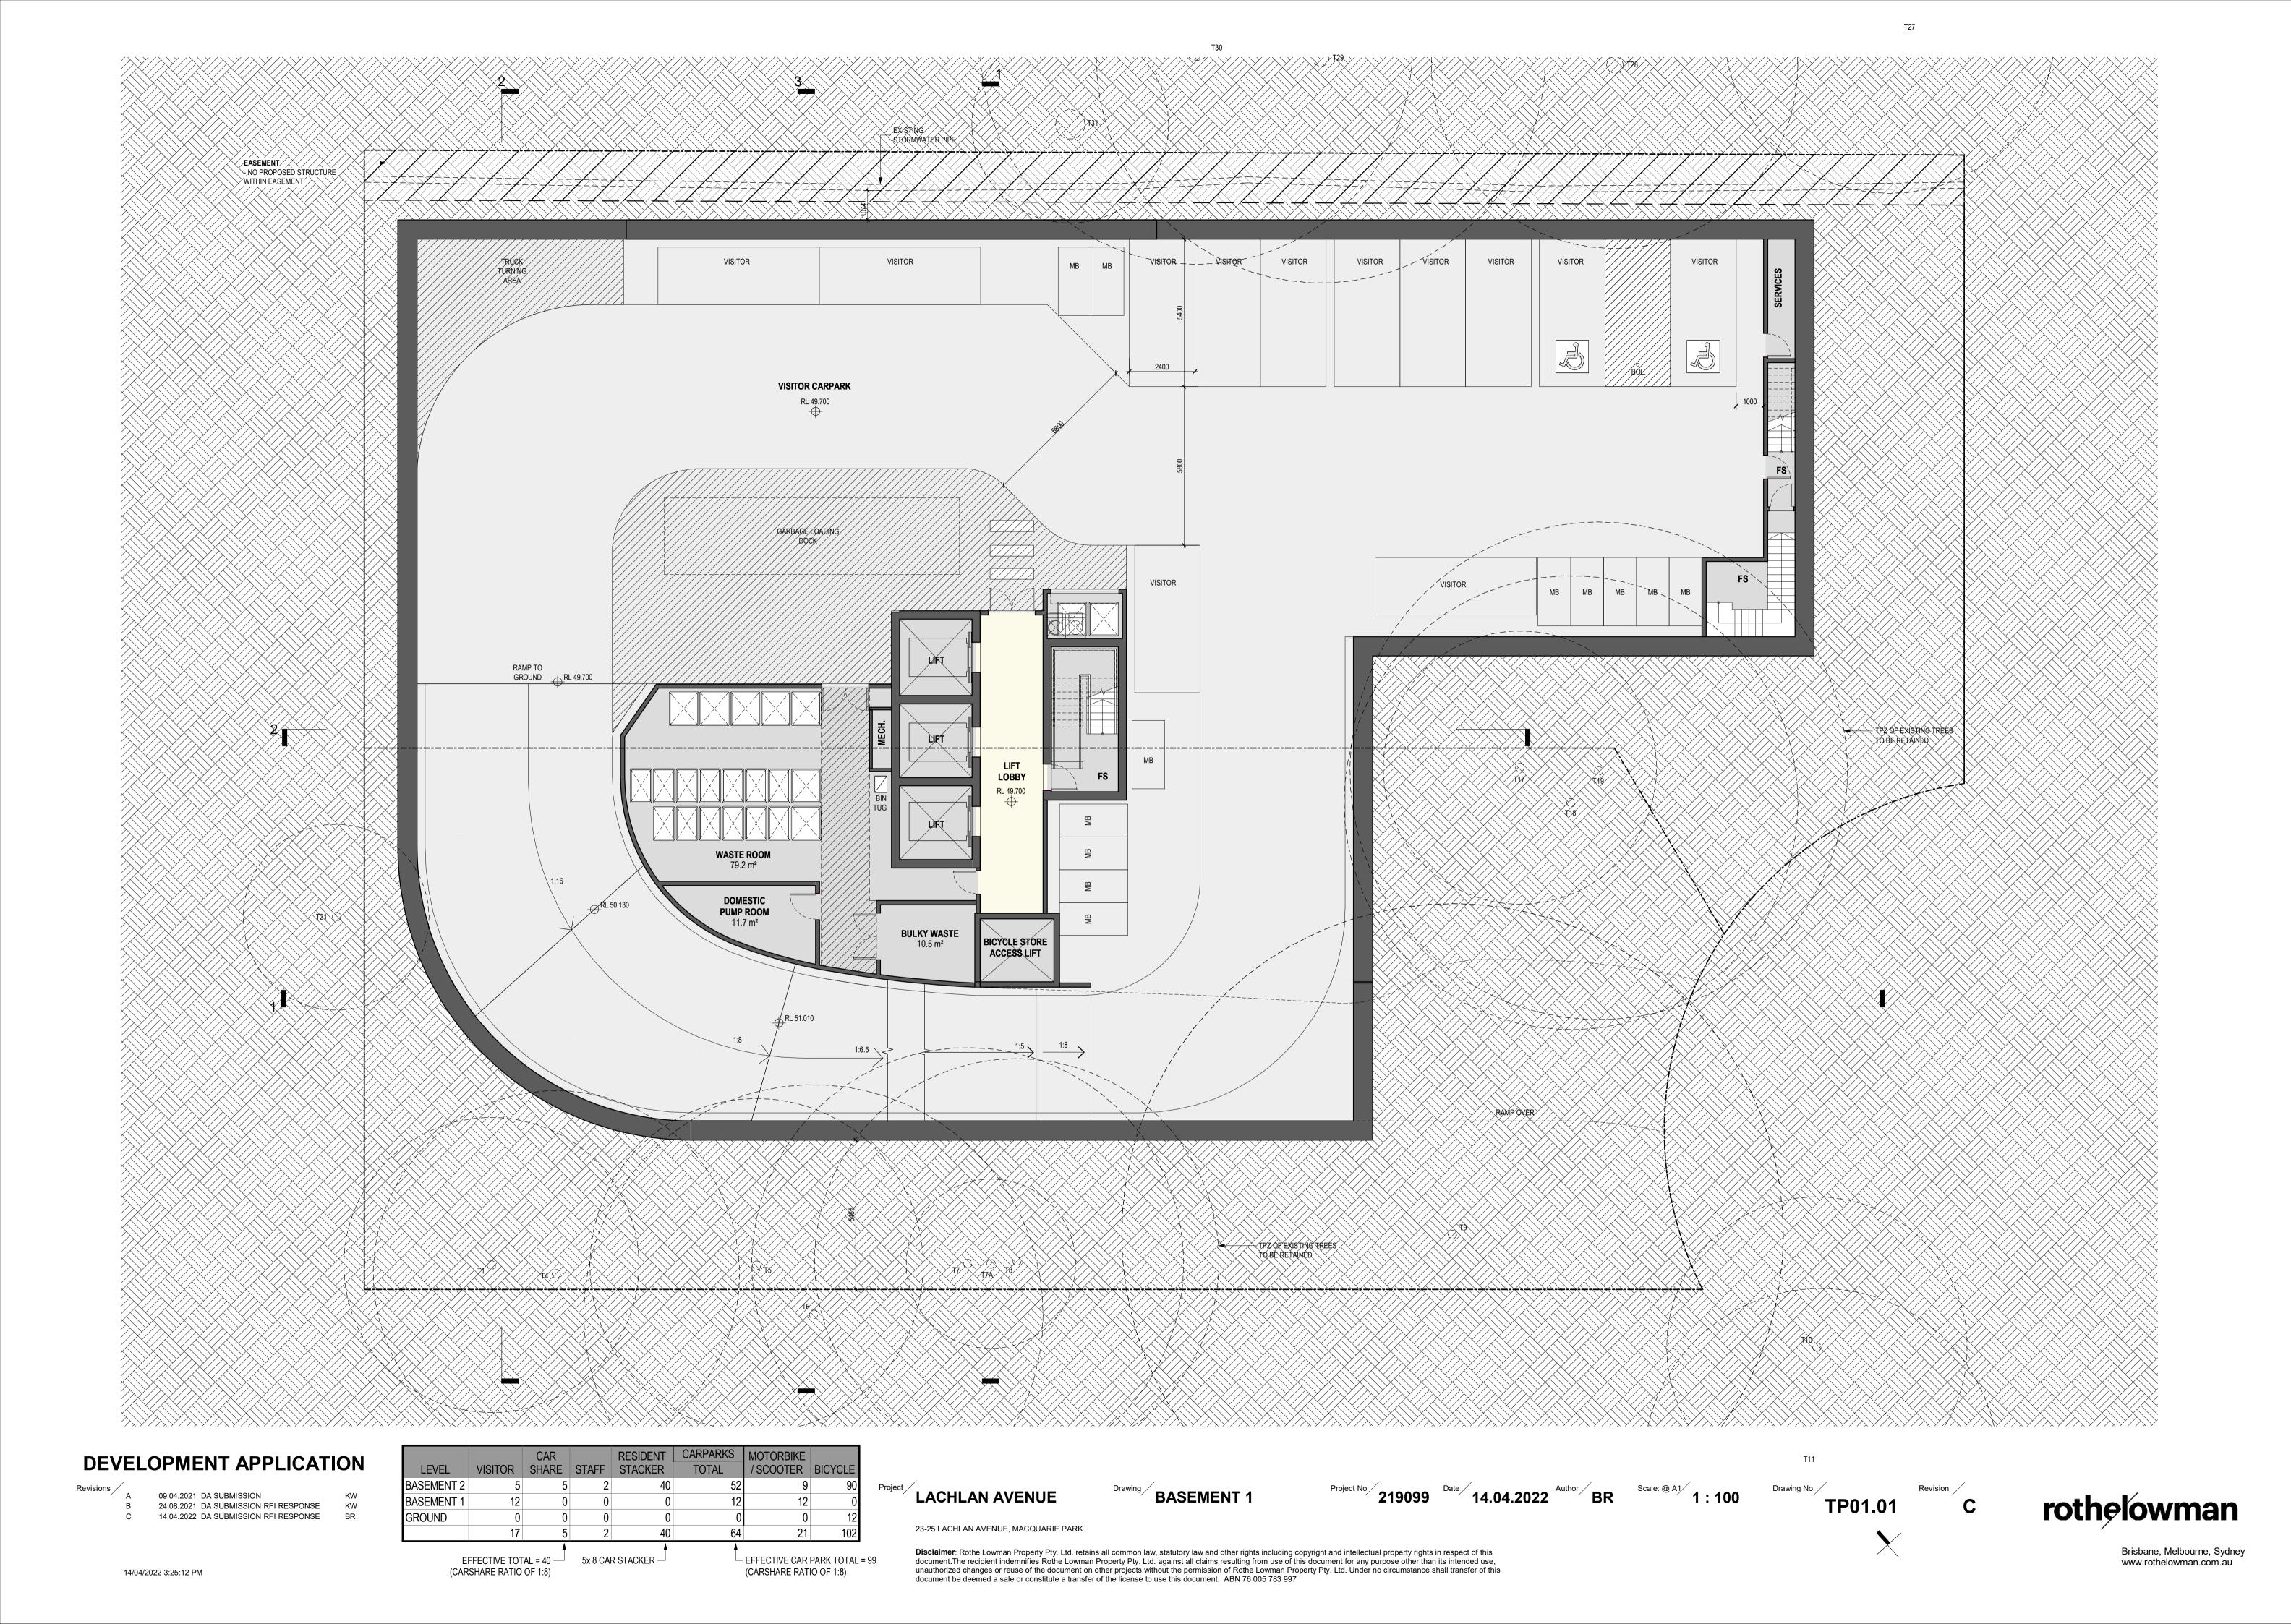



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POLICY (AFFORDABLE RENTAL HOUSING) 2009





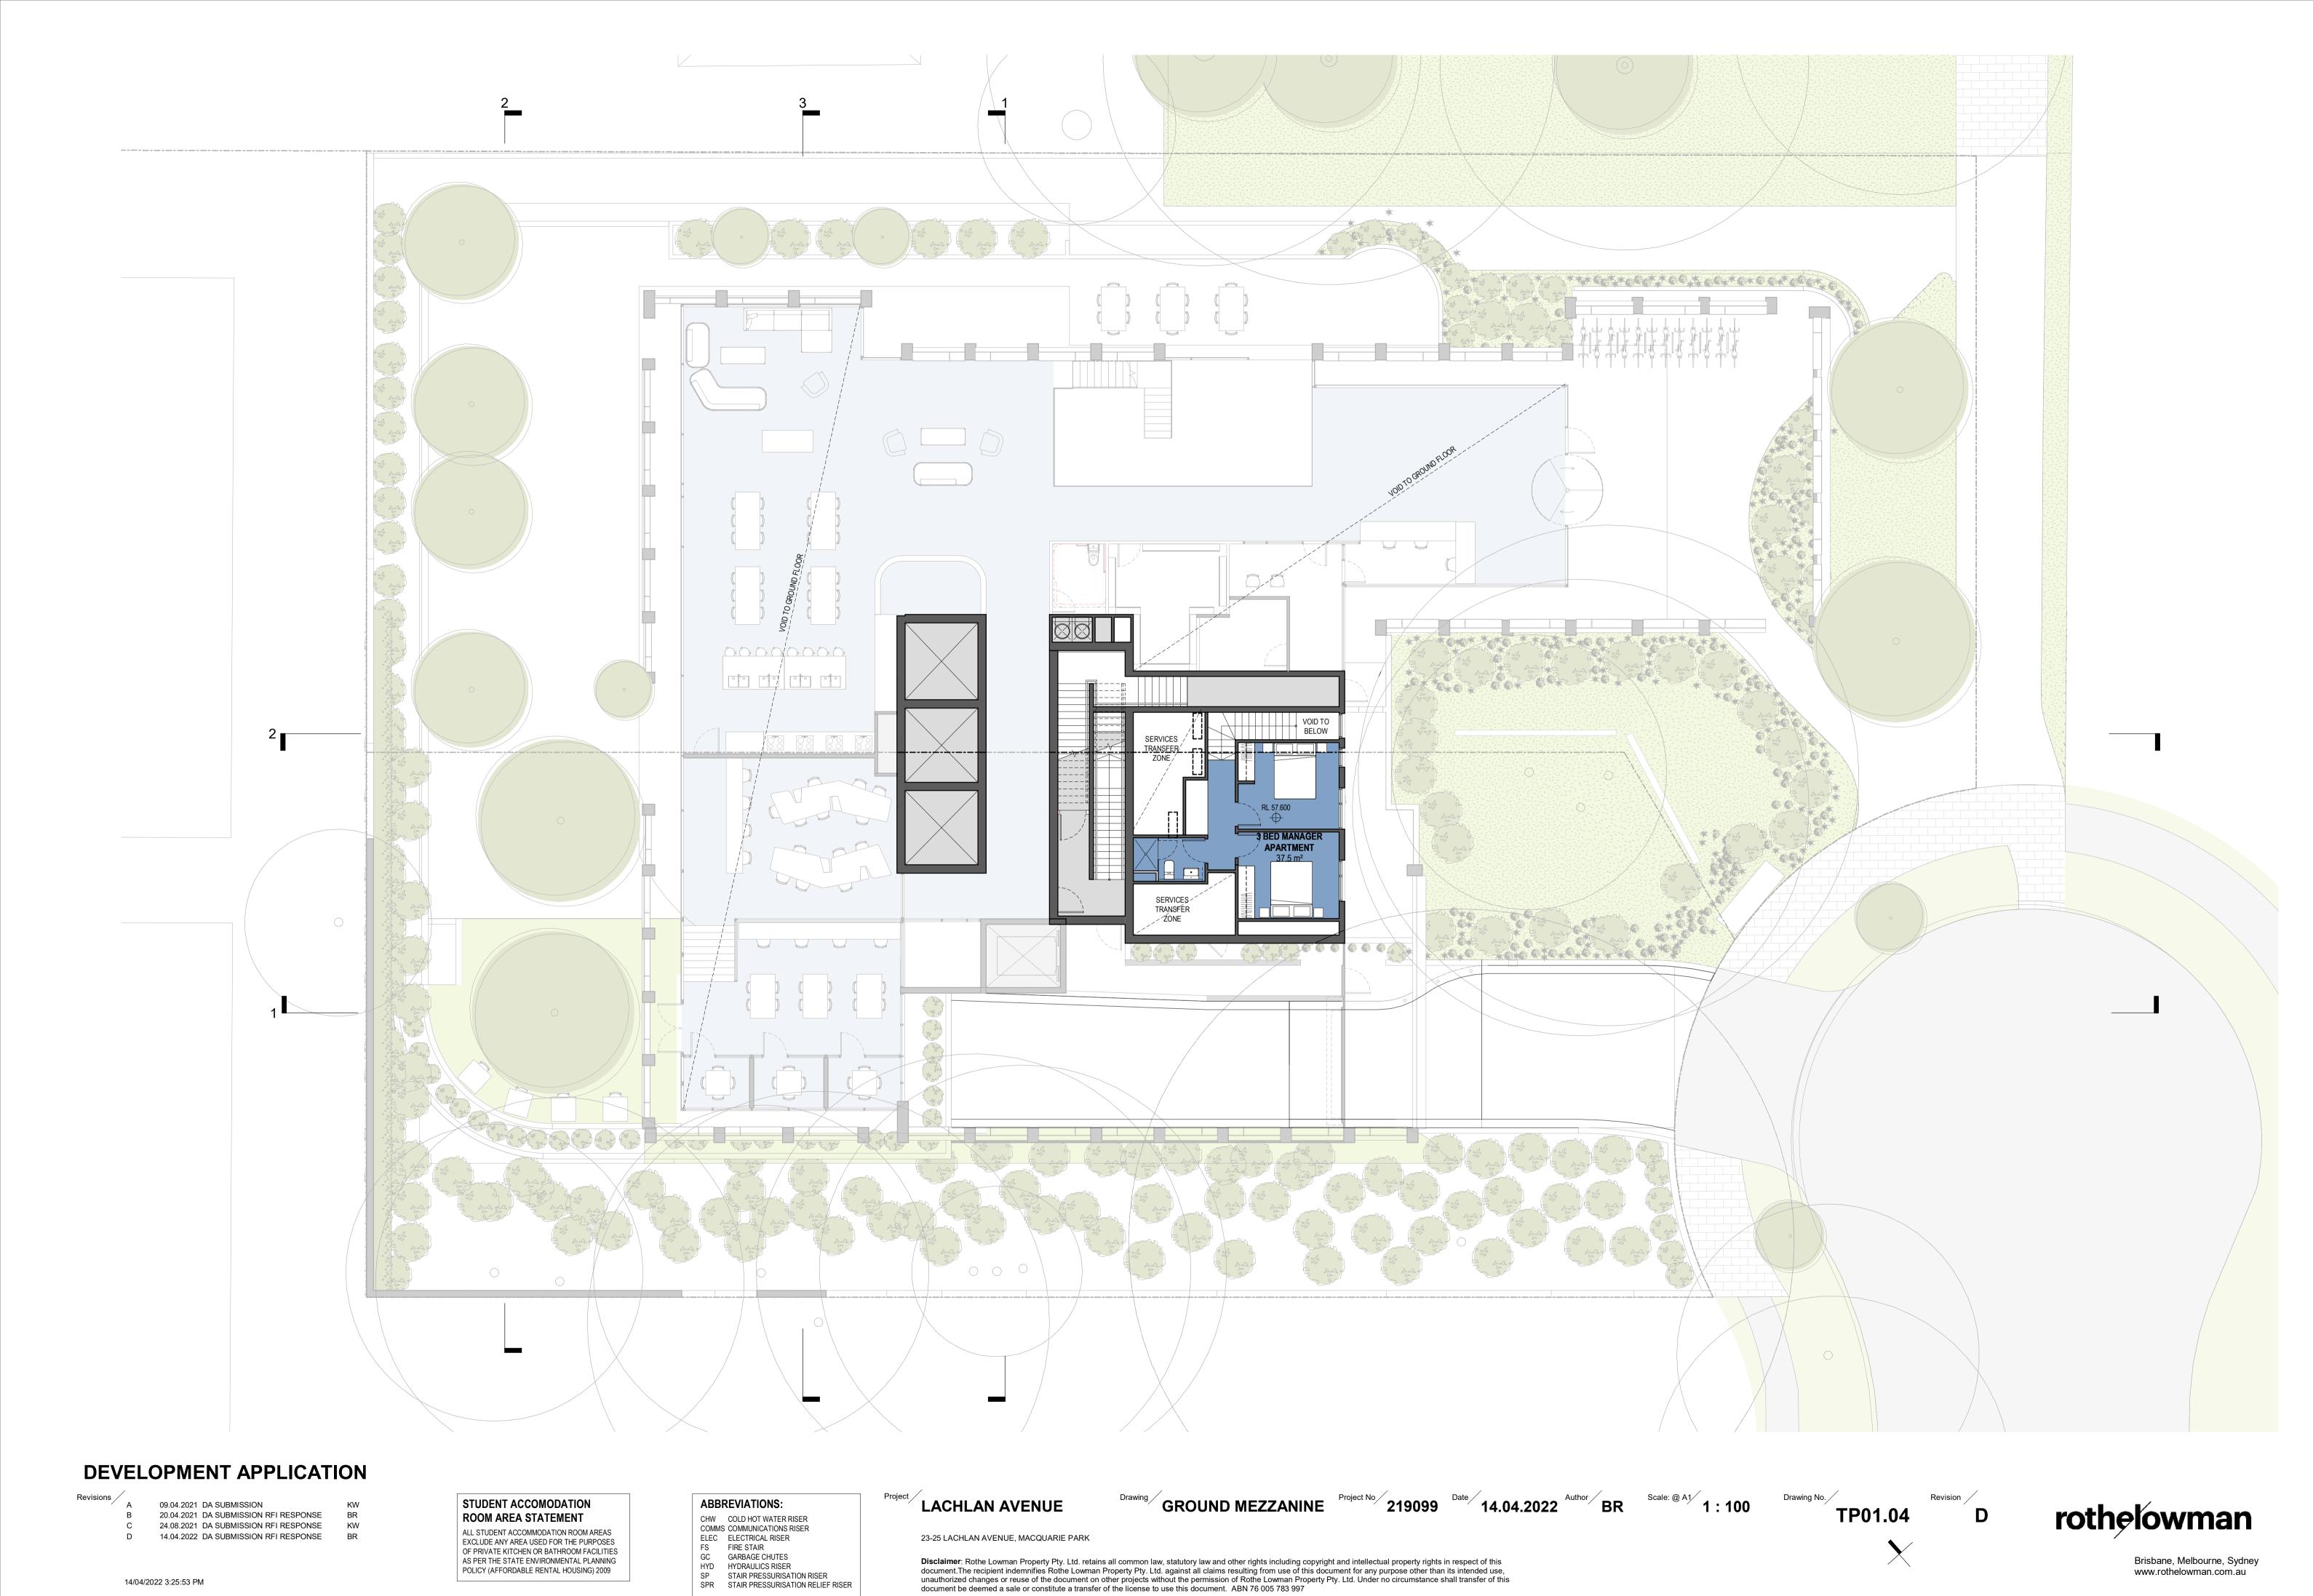

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POLICY (AFFORDABLE RENTAL HOUSING) 2009

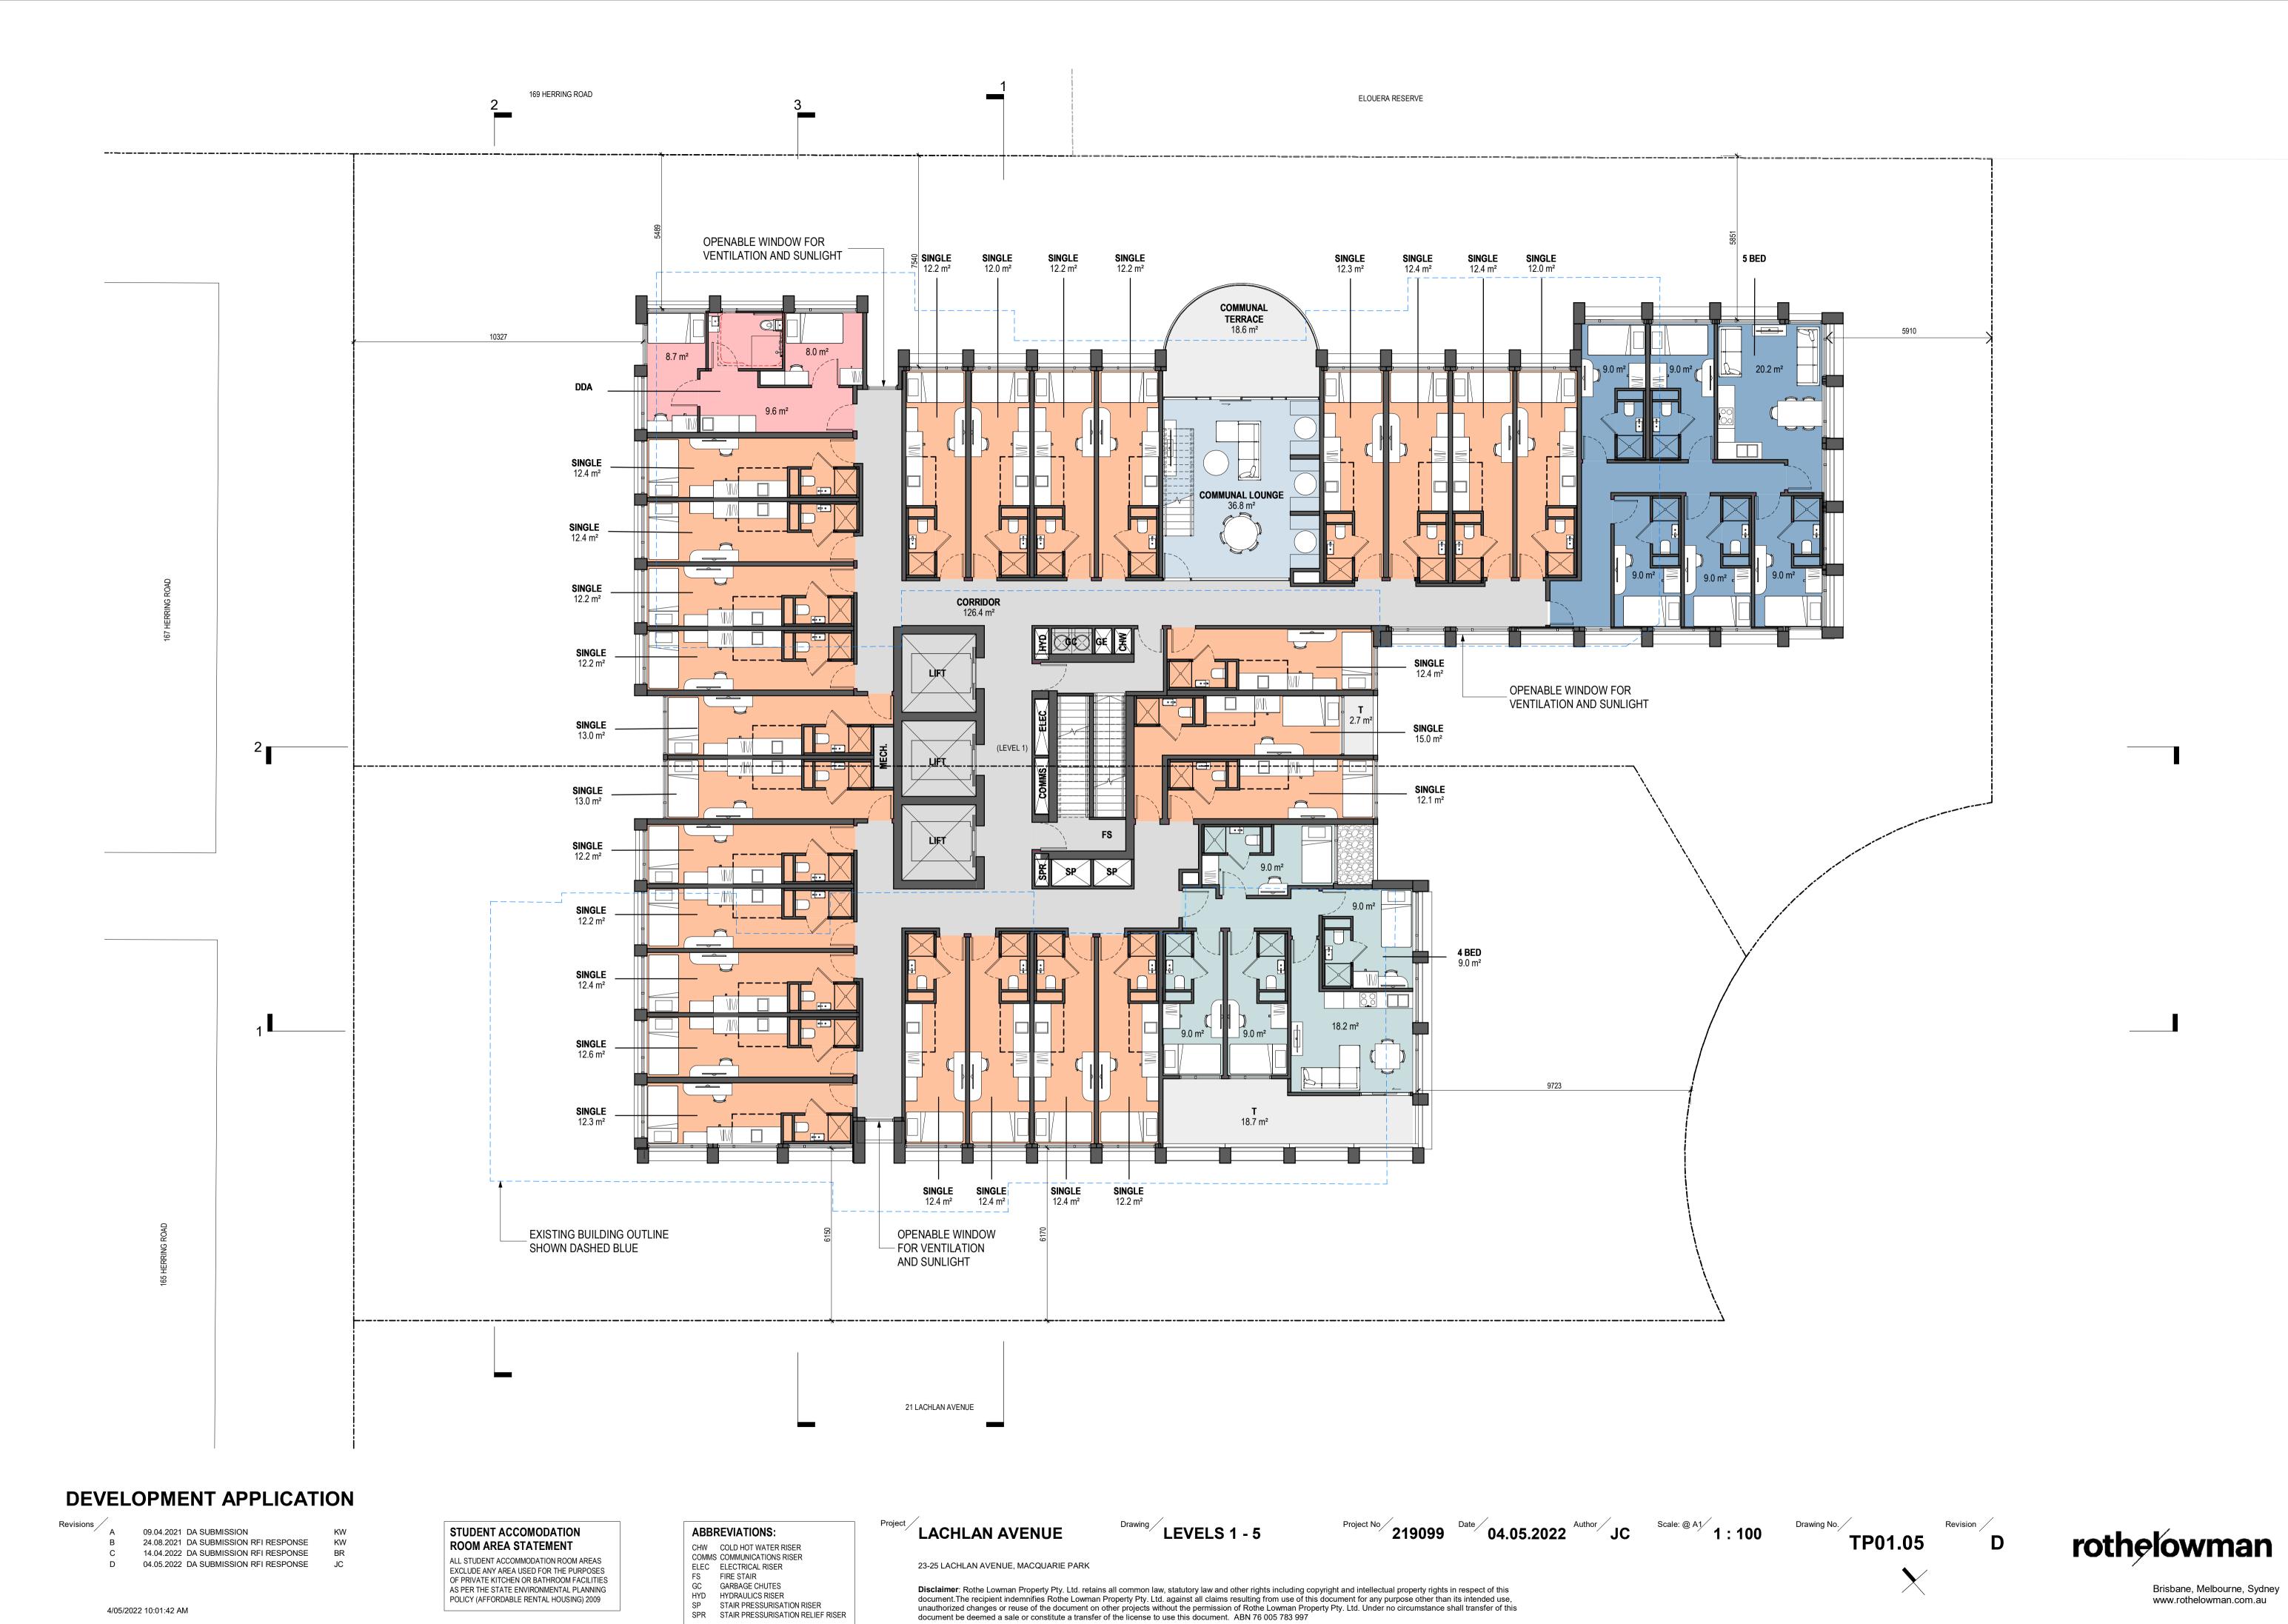
SPR STAIR PRESSURISATION RELIEF RISER




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24.08.2021 DA SUBMISSION RFI RESPONSE KW 14.04.2022 DA SUBMISSION RFI RESPONSE BR 04.05.2022 DA SUBMISSION RFI RESPONSE JC

ROOM AREA STATEMENT ALL STUDENT ACCOMMODATION ROOM AREAS EXCLUDE ANY AREA USED FOR THE PURPOSES OF PRIVATE KITCHEN OR BATHROOM FACILITIES AS PER THE STATE ENVIRONMENTAL PLANNING POLICY (AFFORDABLE RENTAL HOUSING) 2009

STUDENT ACCOMODATION

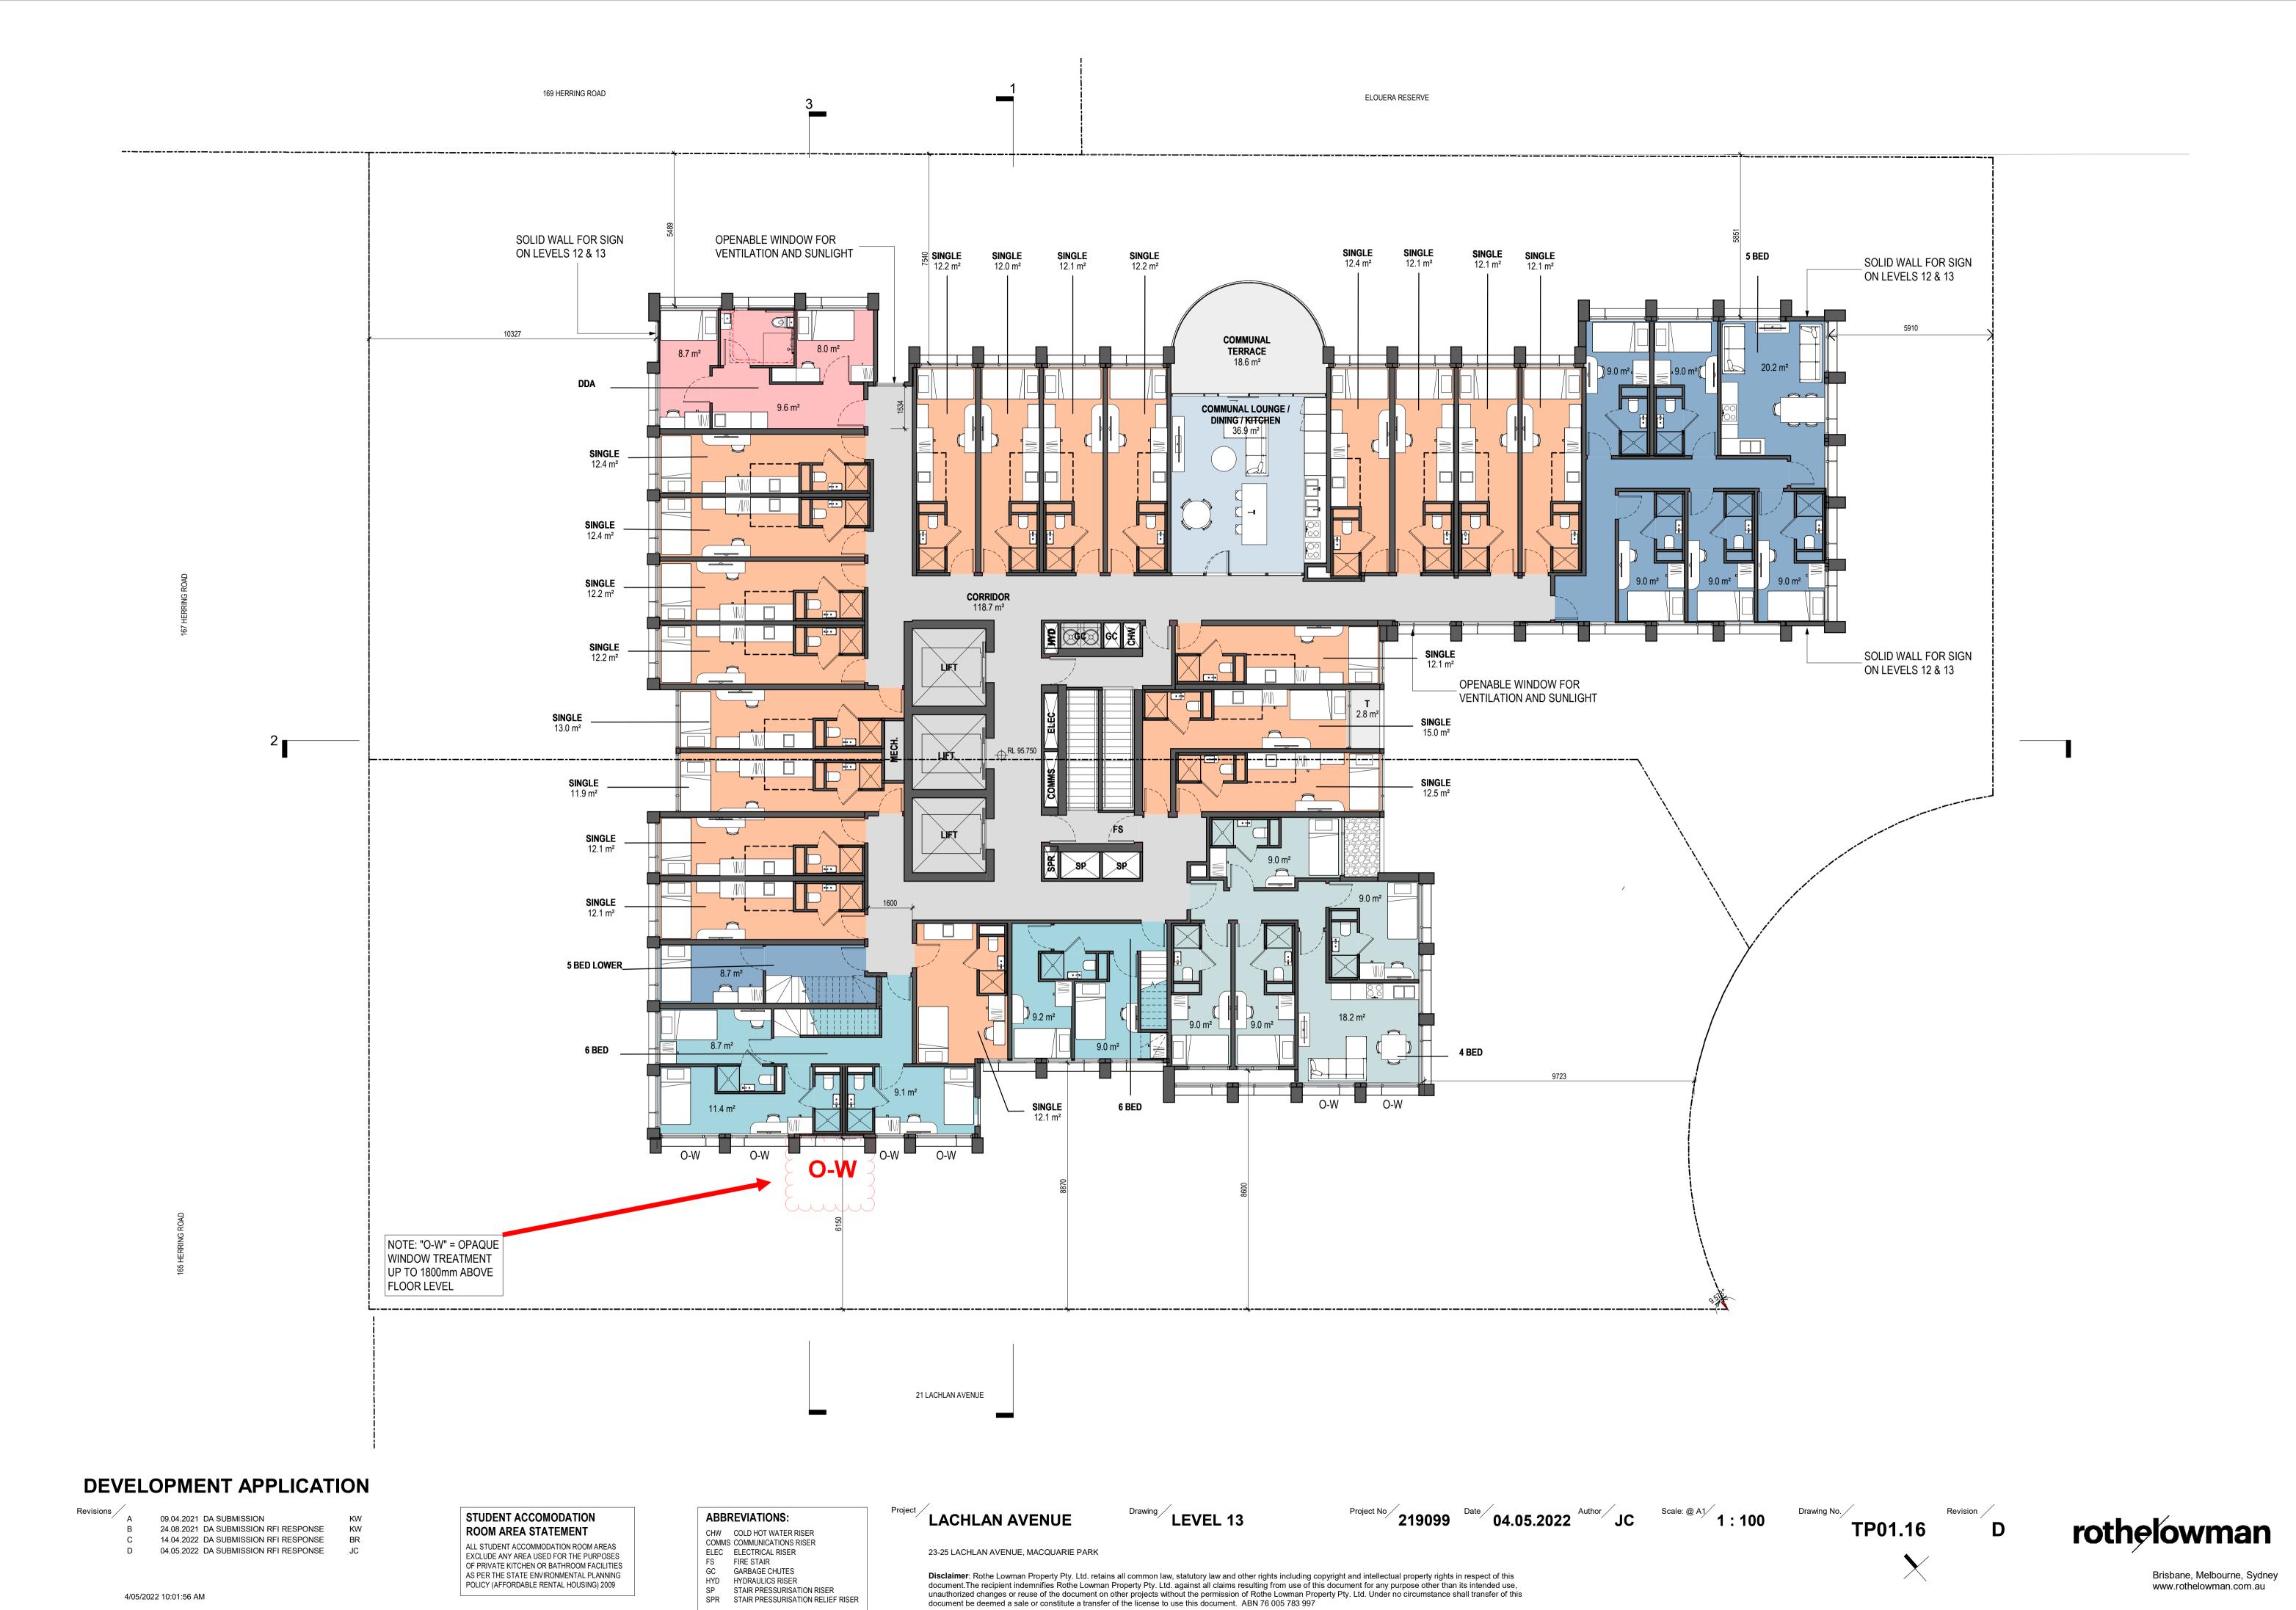ABBREVIATIONS: CHW COLD HOT WATER RISER COMMS COMMUNICATIONS RISER ELEC ELECTRICAL RISER
FS FIRE STAIR
GC GARBAGE CHUTES

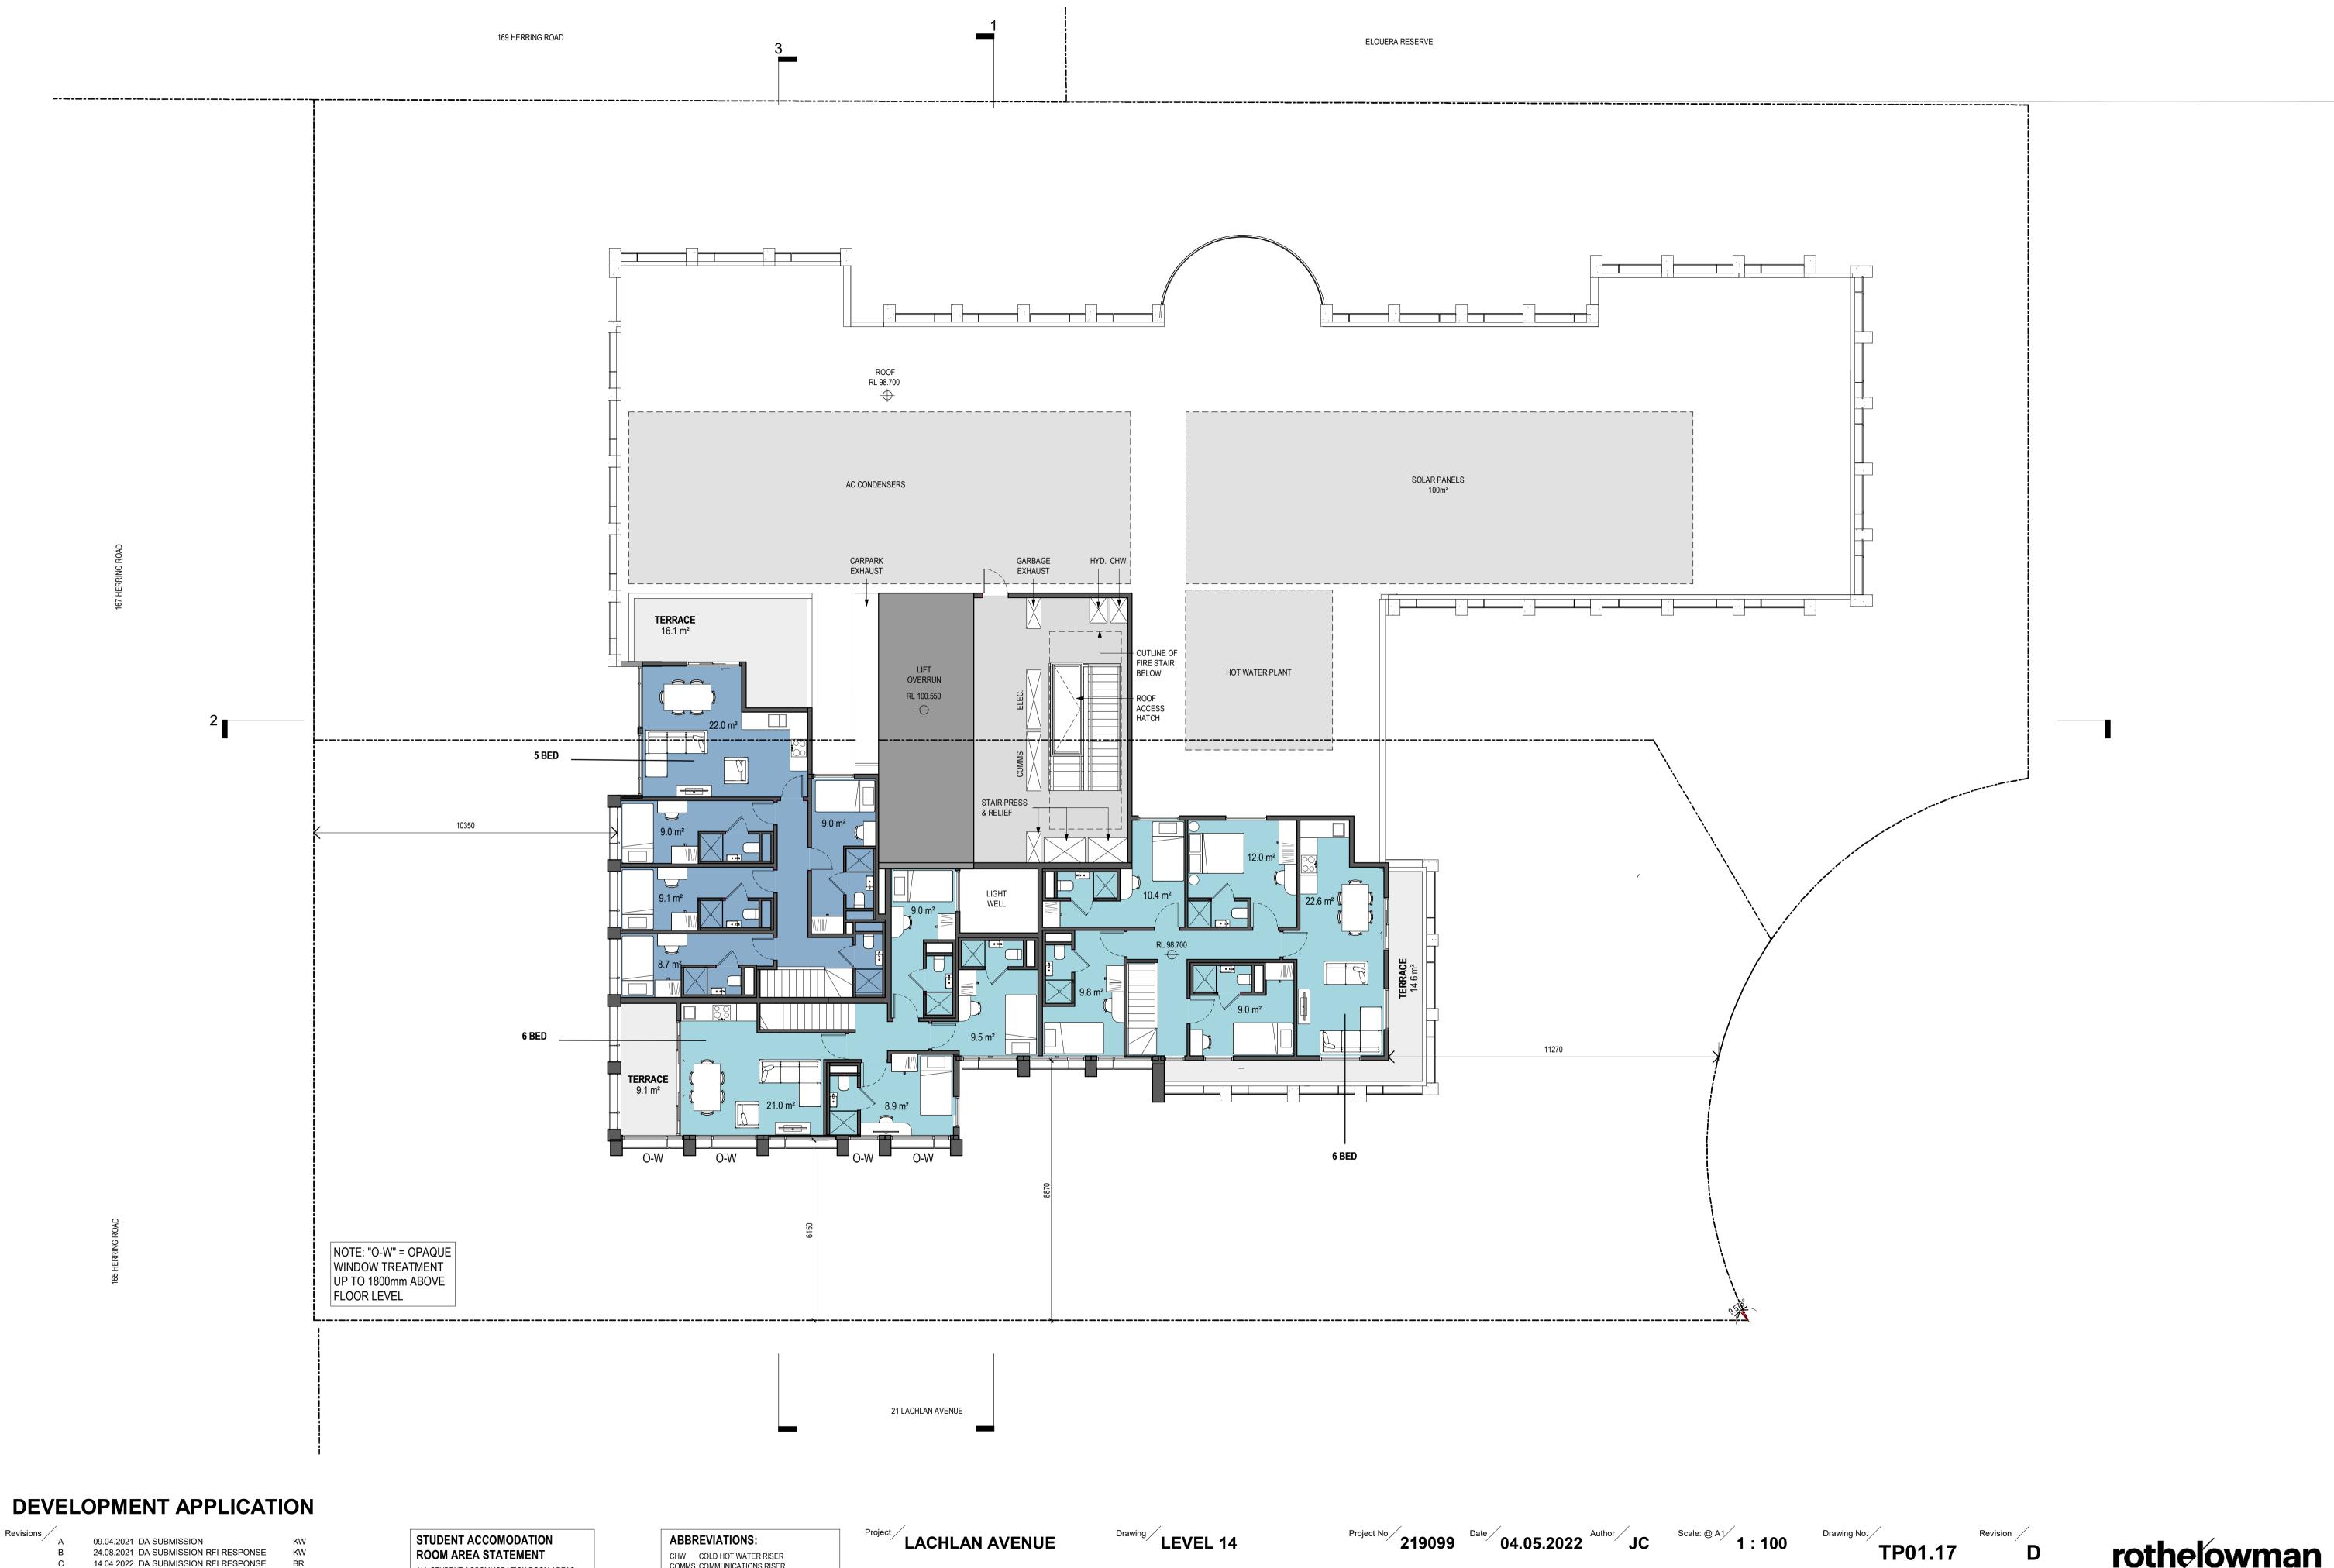
HYD HYDRAULICS RISER
SP STAIR PRESSURISATION RISER

SPR STAIR PRESSURISATION RELIEF RISER

LACHLAN AVENUE

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**ELEVATION WEST ELEVATION NORTH** 

## **DEVELOPMENT APPLICATION**

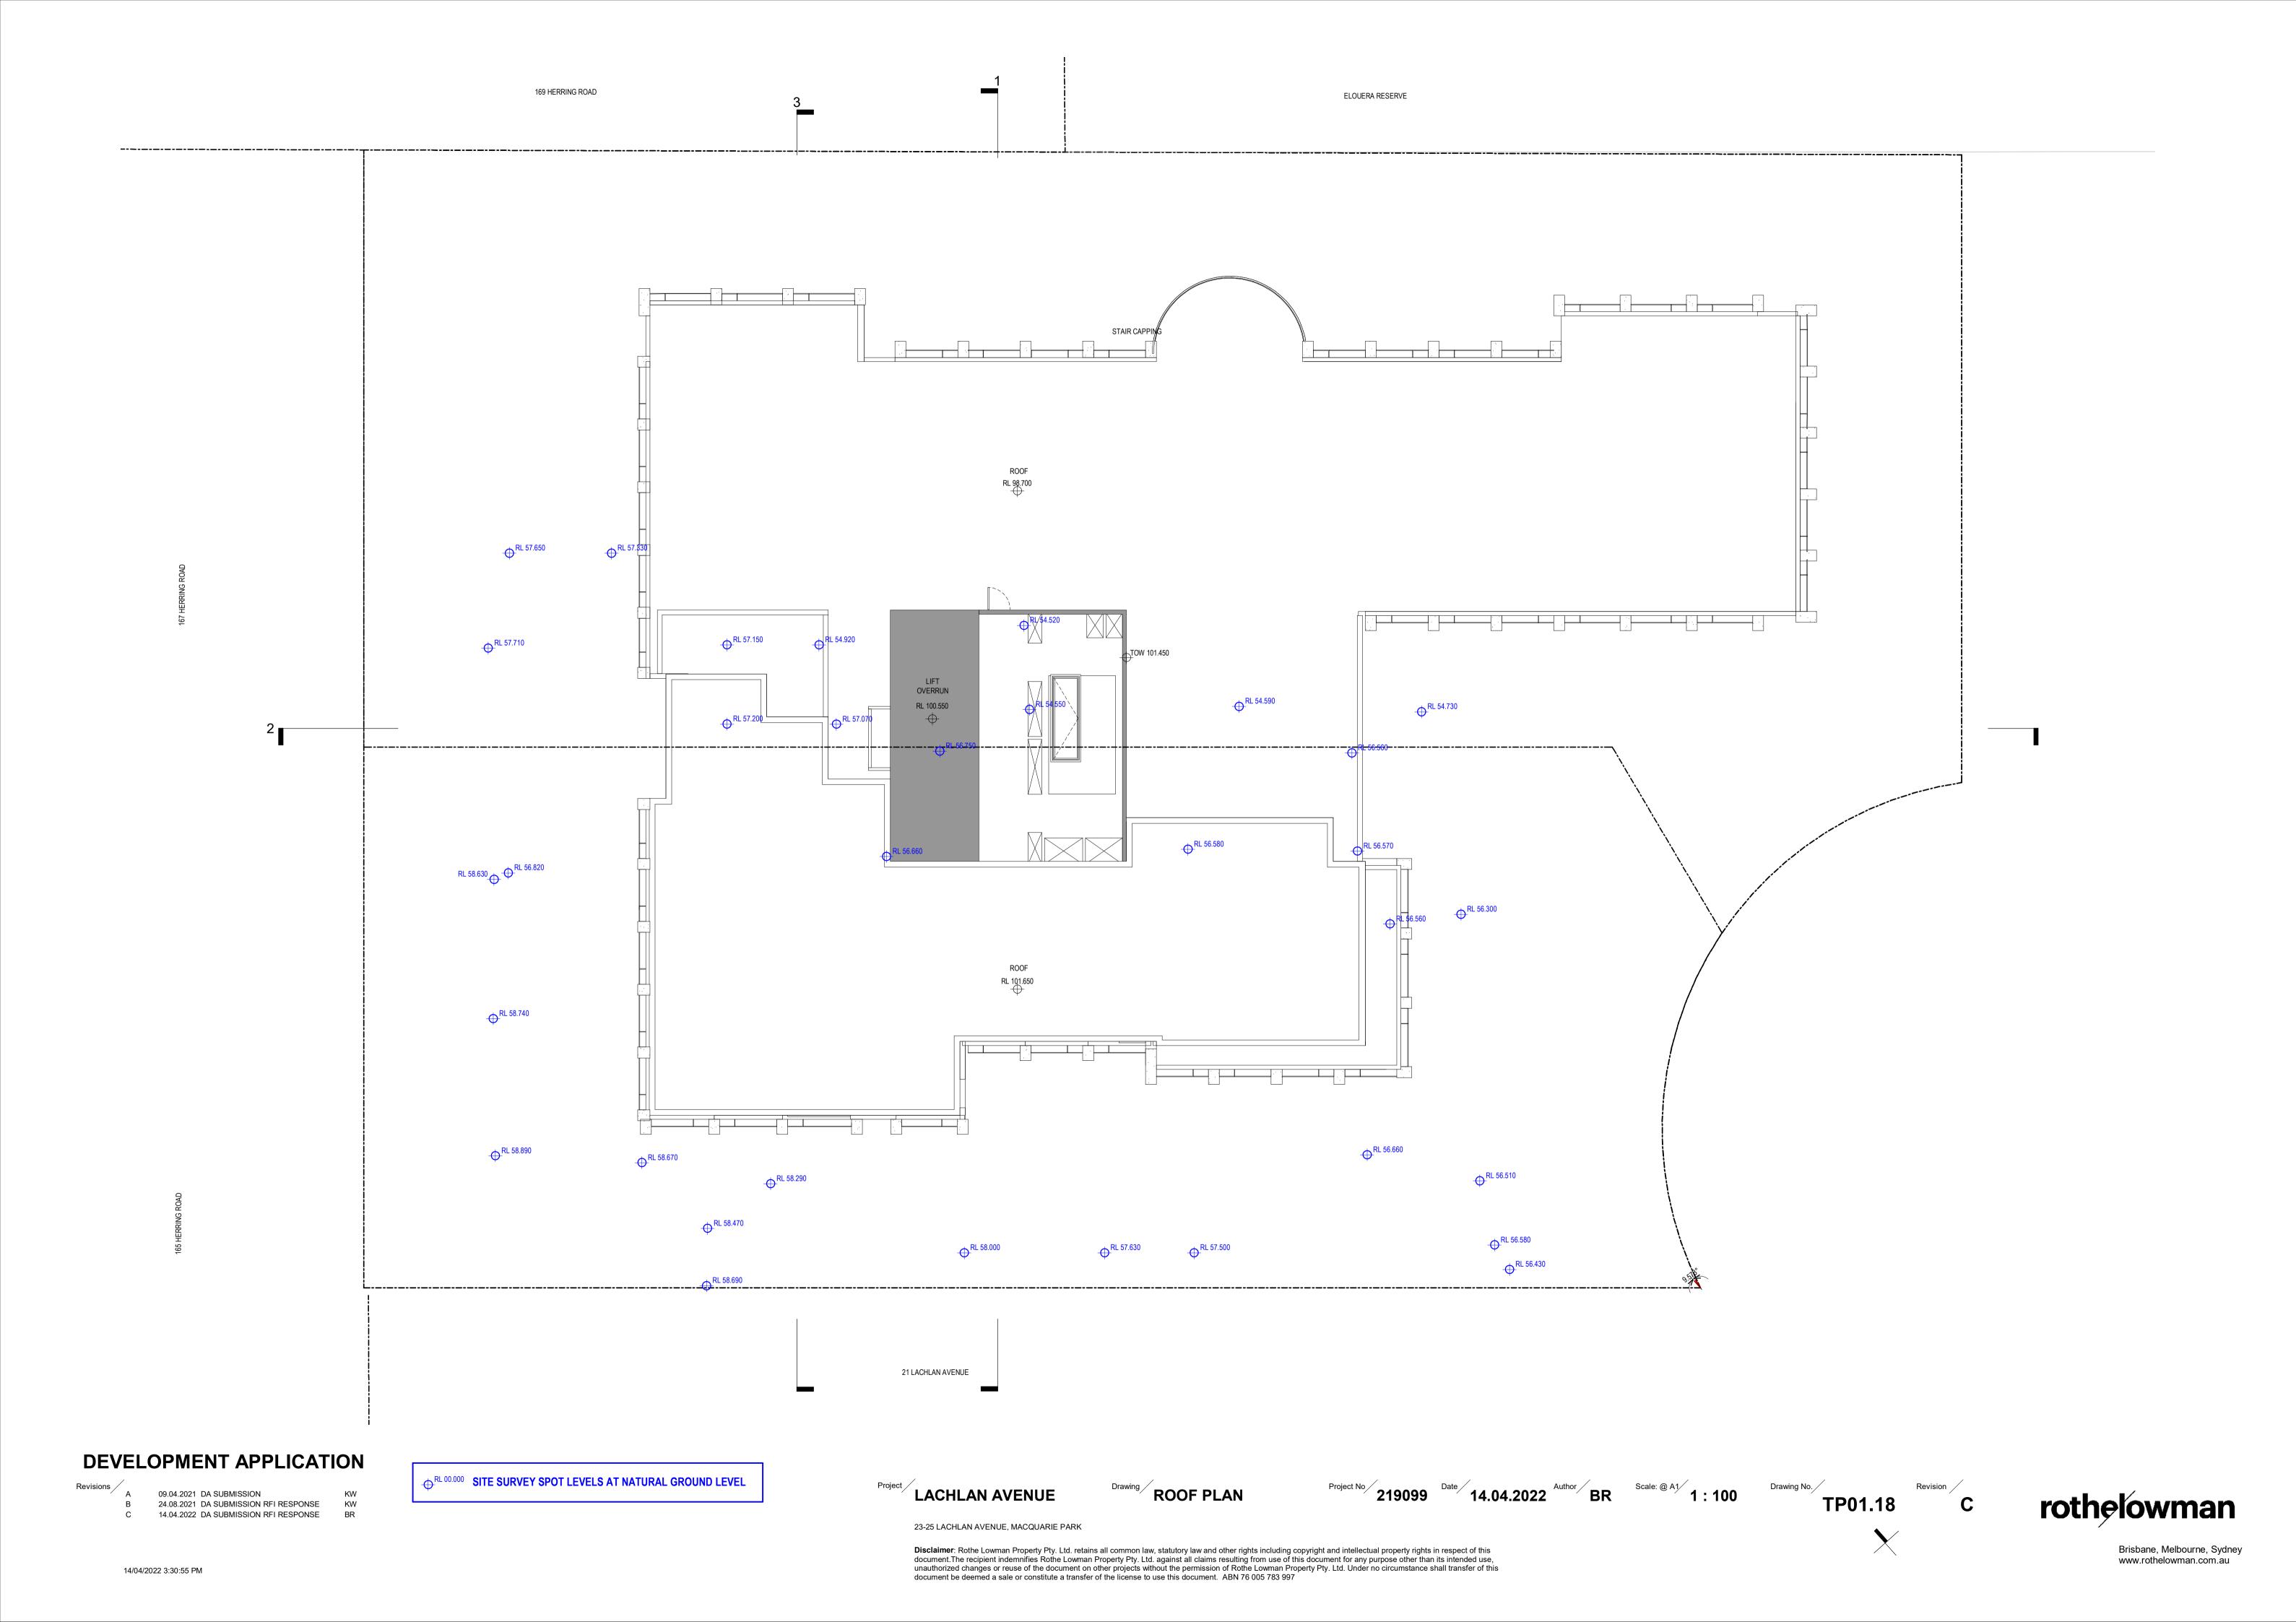09.04.2021 DA SUBMISSION 24.08.2021 DA SUBMISSION RFI RESPONSE

14.04.2022 DA SUBMISSION RFI RESPONSE

**FINISHES LEGEND** REFER TO EXTERIOR FINISHES DRAWING TP10.12 (AFXX) APPLIED FINISH GTXX) GLAZING

MFXX) METAL FINISH

**LACHLAN AVENUE** 

**ELEVATIONS 01** 

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B 20.04.2021 DA SUBMISSION RFI RESPONSE BR
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D 14.04.2022 DA SUBMISSION RFI RESPONSE BR

FINISHES LEGEND

REFER TO EXTERIOR FINISHES DRAWING TP10.12

AFXX APPLIED FINISH

GTXX GLAZING

MFXX METAL FINISH

LACHLAN AVENUE

23-25 LACHLAN AVENUE, MACQUARIE PARK

ELEVATIONS 02

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**219099** Date

..04.2022 Author BR

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TP02.02

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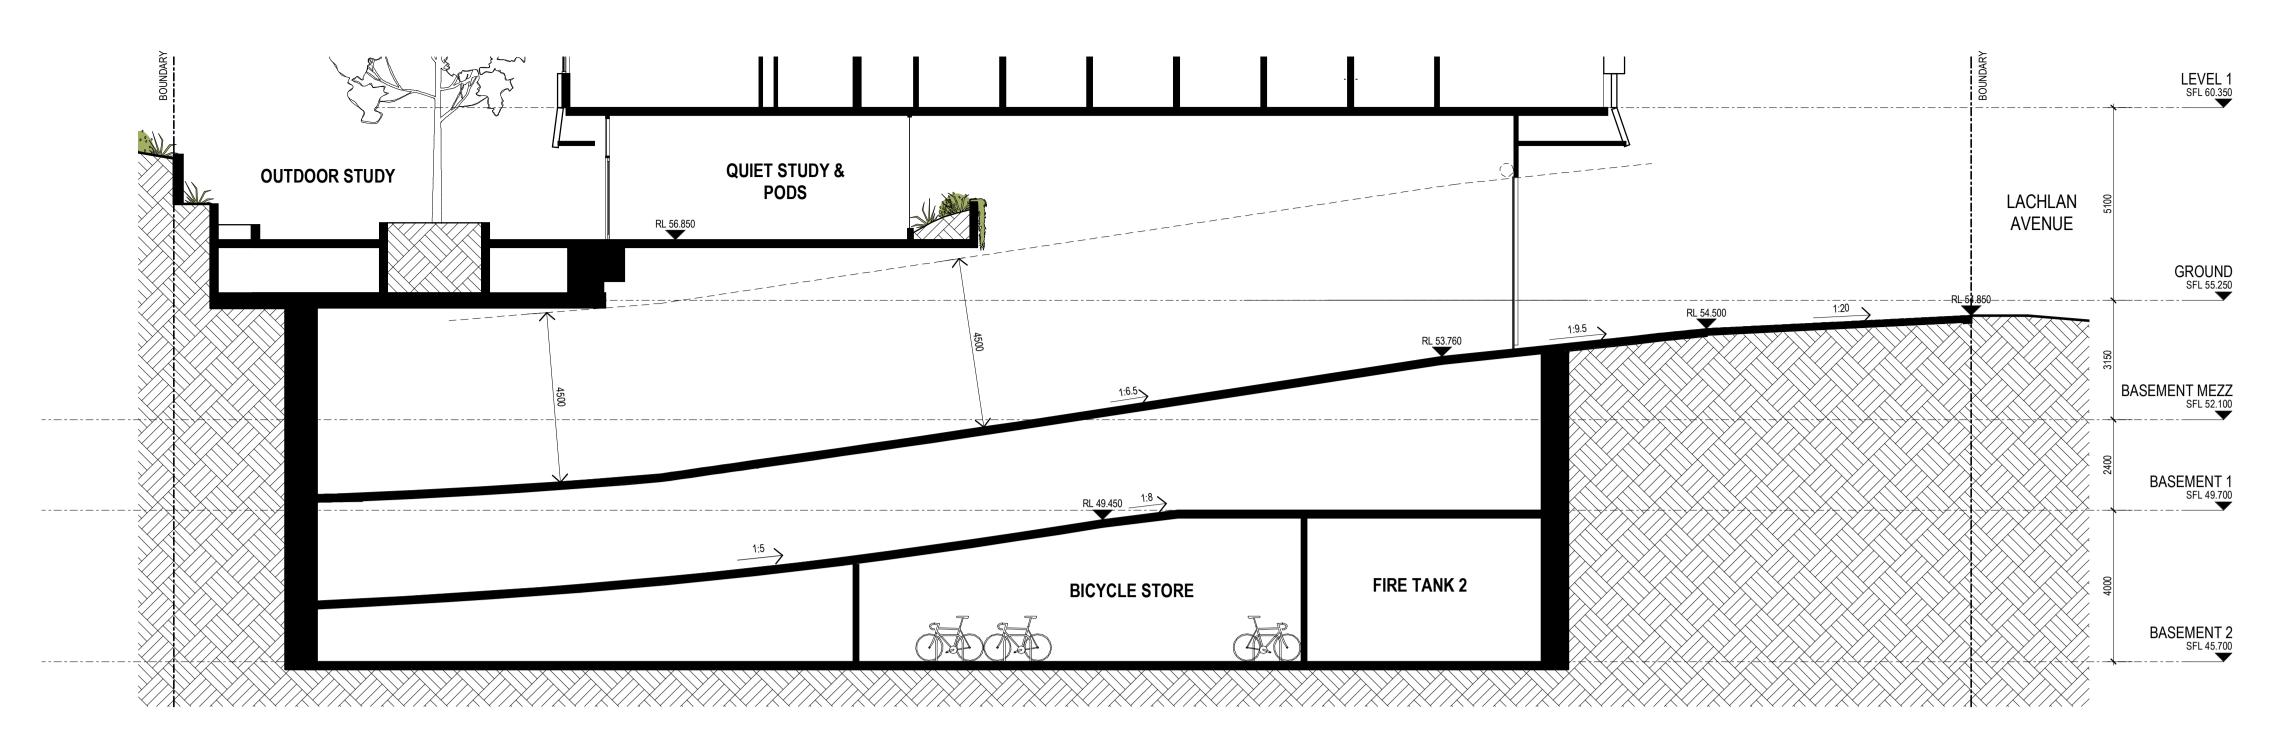
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LACHLAN AVENUE


SECTIONS SECTIONS

Date 14.04.2022 Author BR Scale: @ A1 1: 200 TP03.01

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RAMP SECTION 1 - UPPER



RAMP SECTION 2 - LOWER

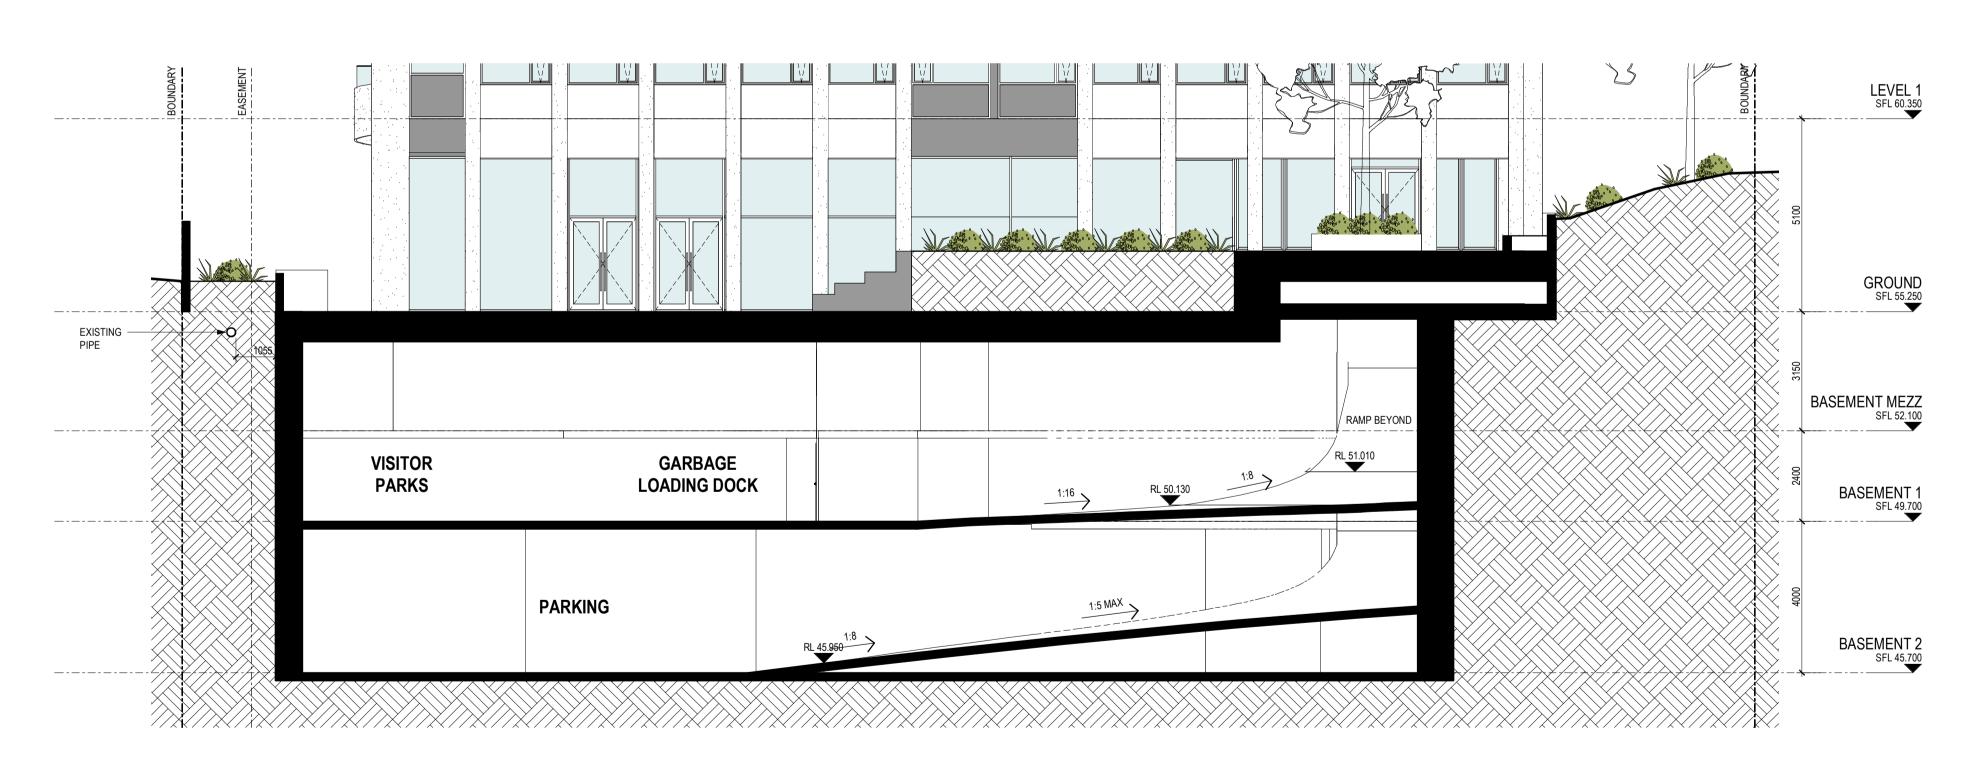
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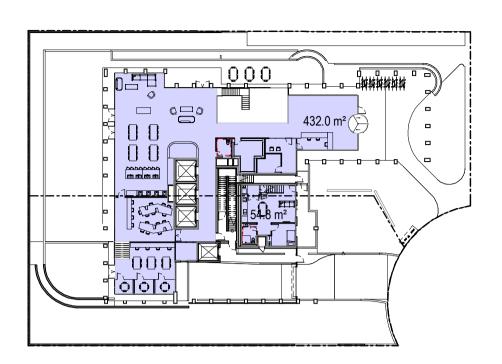
LACHLAN AVENUE


23-25 LACHLAN AVENUE, MACQUARIE PARK


CAR PARK RAMP **SECTIONS** 

Date 14.04.2022 Author BR Scale: @ A1 1: 100 TP03.05



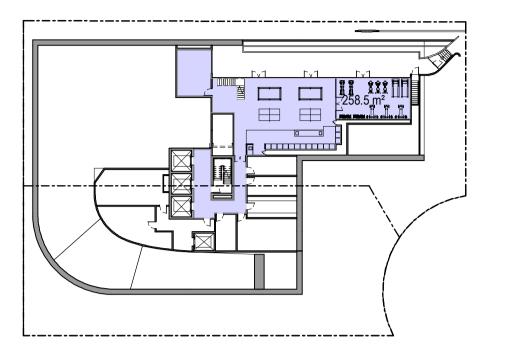

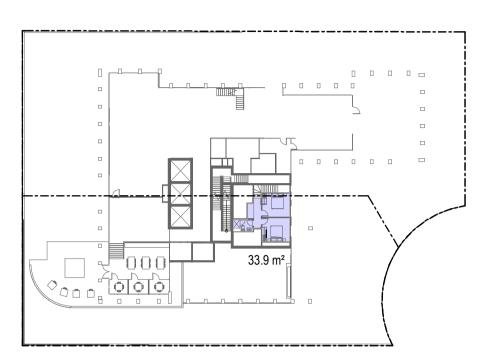

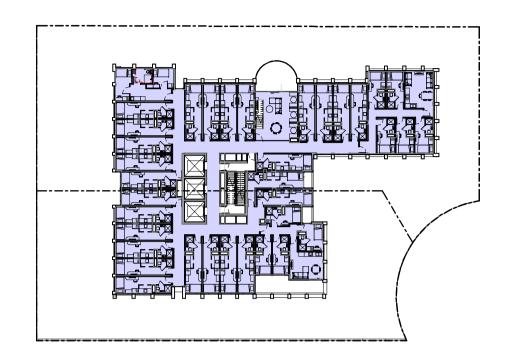



**BASEMENT MEZZANINE** 


GROUND

**GROUND MEZZANINE** 

**LEVEL 1** -5

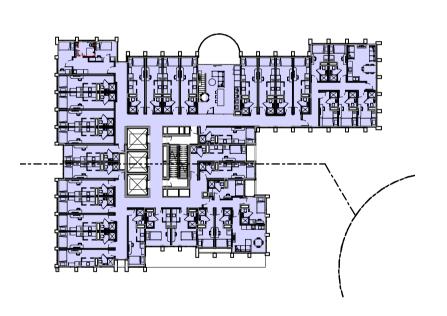

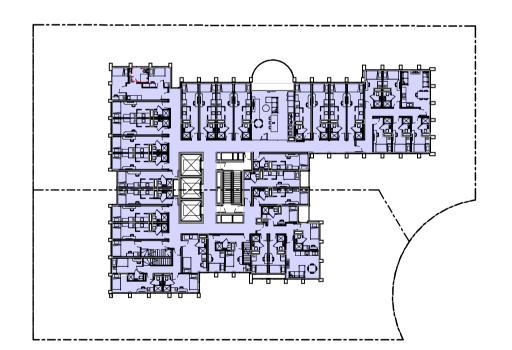

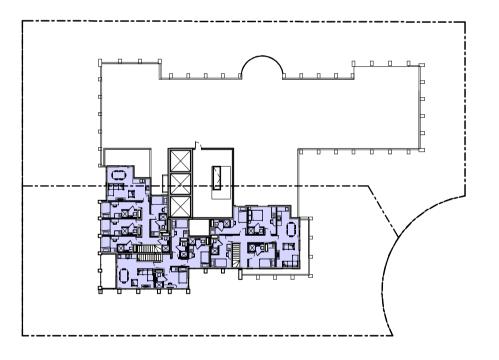

**LEVEL 6 - 12** 

LEVEL 13

LEVEL 14

SITE AREA	PERMISSIBLE FSR	PERMISSIBLE GFA
2266.6 m <sup>2</sup>	4	9066.5 m <sup>2</sup>
SITE AREA	ARHSEPP FSR	ALLOWABLE GFA
2266.6 m²	4.8	10879.8 m²

TP - GFA				
Level	Area			
BASEMENT MEZZ	258.5 m <sup>2</sup>			
GROUND	486.8 m²			
MEZZANINE	33.9 m²			
LEVEL 1	770.8 m <sup>2</sup>			
LEVEL 2	770.8 m <sup>2</sup>			
LEVEL 3	770.8 m <sup>2</sup>			
LEVEL 4	770.8 m²			
LEVEL 5	770.8 m²			
LEVEL 6	752.7 m <sup>2</sup>			
LEVEL 7	752.7 m <sup>2</sup>			
LEVEL 8	752.7 m²			
LEVEL 9	752.7 m²			
LEVEL 10	752.7 m <sup>2</sup>			
LEVEL 11	752.7 m²			
LEVEL 12	752.7 m²			
LEVEL 13	760.0 m <sup>2</sup>			
LEVEL 14	216.8 m <sup>2</sup>			
TOTAL: 18	10879.0 m²			

## GFA Definition - Ryde LEP

gross floor area means the sum of the floor area of each floor of a building measured from the internal face of

external walls, or from the internal face of walls separating the building from any other building, measured at a height of 1.4 metres above the floor, and includes—

(a) the area of a mezzanine, and

(b) habitable rooms in a basement or an attic, and

(c) any shop, auditorium, cinema, and the like, in a basement or attic,

but excludes—

(d) any area for common vertical circulation, such as lifts and stairs, and

(e) any basement—

(i) storage, and (ii) vehicular access, loading areas, garbage and services, and

(f) plant rooms, lift towers and other areas used exclusively for mechanical services or ducting, and


(g) car parking to meet any requirements of the consent authority (including access to that car parking), and (h) any space used for the loading or unloading of goods (including access to it), and

(i) terraces and balconies with outer walls less than 1.4 metres high, and

(j) voids above a floor at the level of a storey or storey above.


**DEVELOPMENT APPLICATION** 


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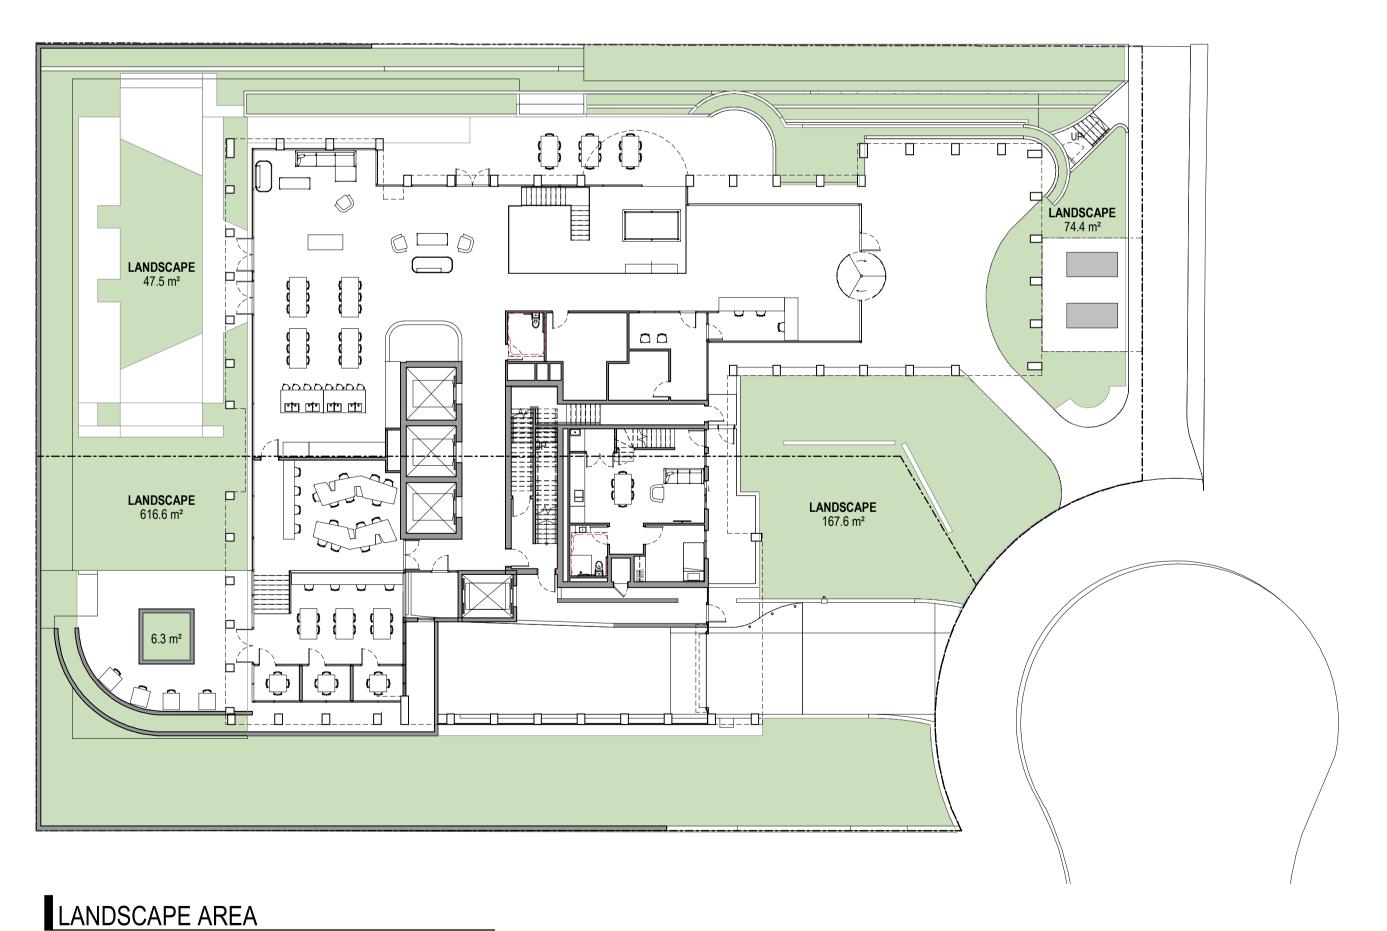

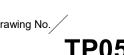
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NOTE: TOTAL SITE AREA = 2266.6sqm



LANDSCAPE AREA

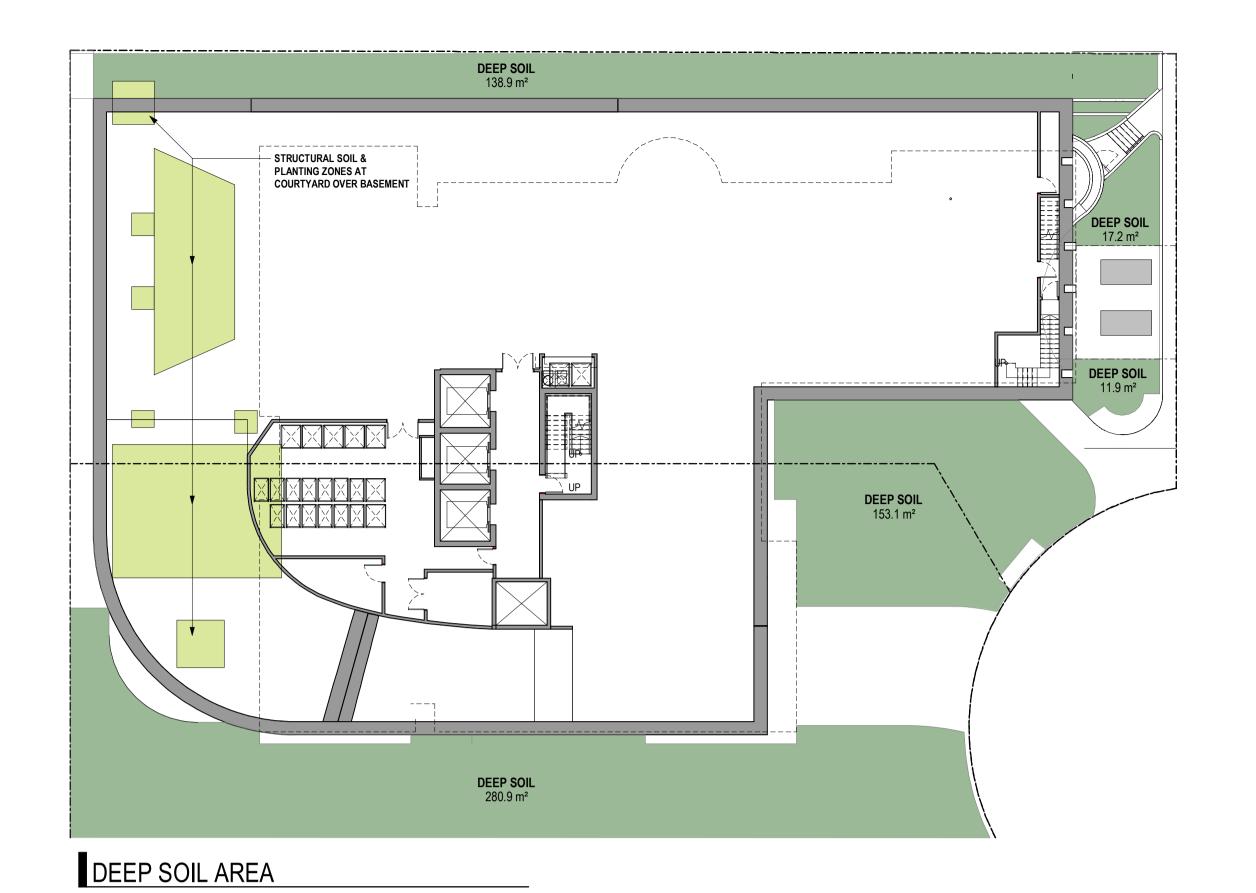LANDSCAPE LANDSCAPE %

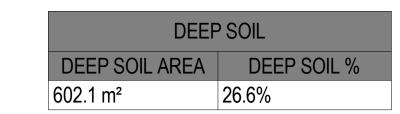913.7 m² 40.3%

NOTE: TOTAL SITE AREA = 2266.6sqm

# **DEVELOPMENT APPLICATION**

A 09.04.2021 DA SUBMISSION KW
B 20.04.2021 DA SUBMISSION RFI RESPONSE BR
C 24.08.2021 DA SUBMISSION RFI RESPONSE KW
D 14.04.2022 DA SUBMISSION RFI RESPONSE BR

LACHLAN AVENUE

23-25 LACHLAN AVENUE, MACQUARIE PARK

LANDSCAPE & DEEP

**219099** Date

14.04.2022 A


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Drawing No.


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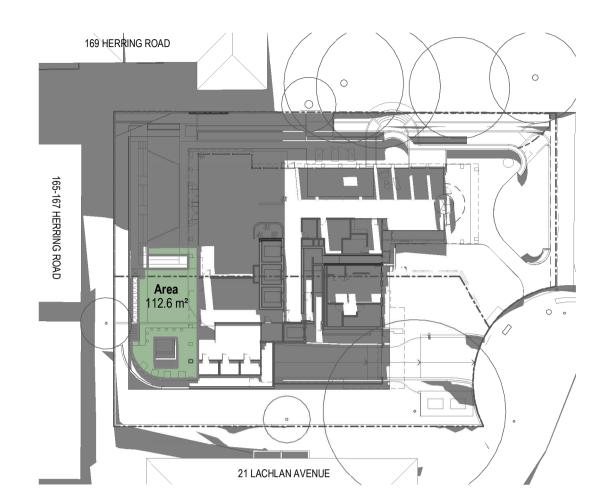
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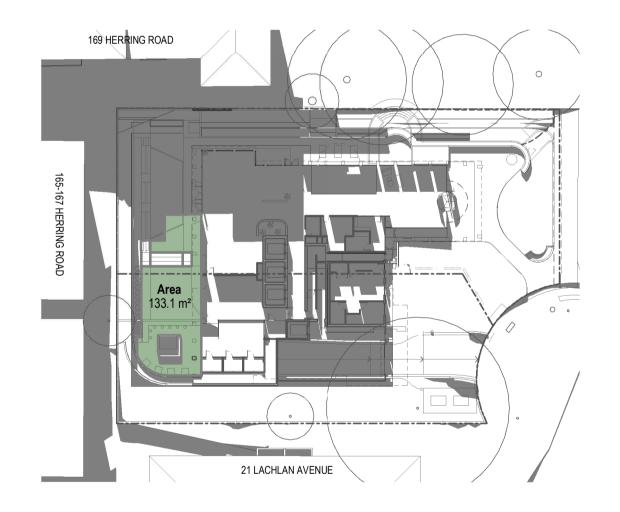
JUNE 21 - 9AM




JUNE 21 - 9:15AM

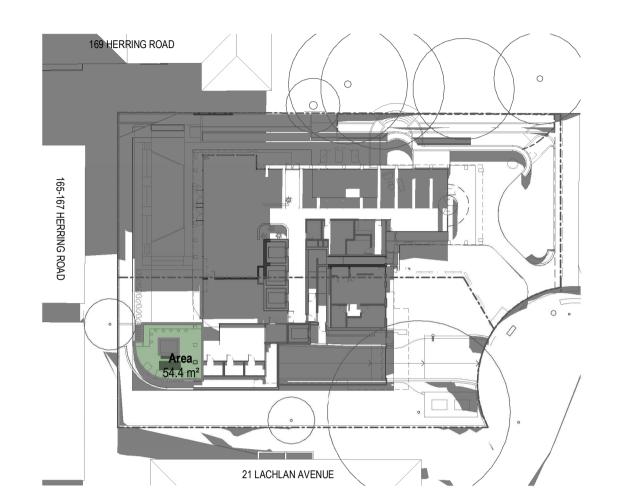


JUNE 21 - 9:30AM

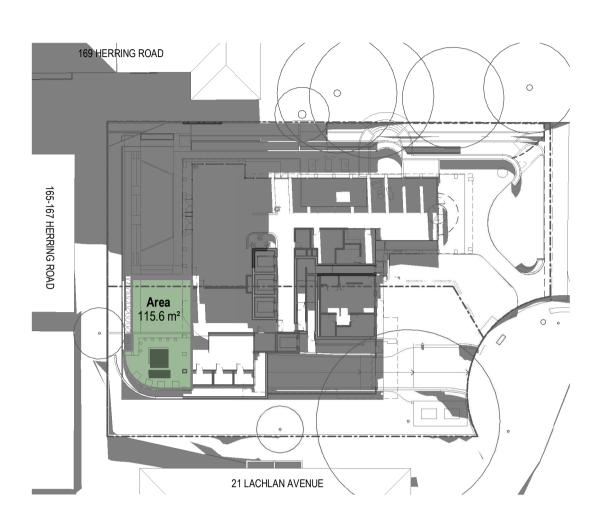

JUNE 21 - 10AM

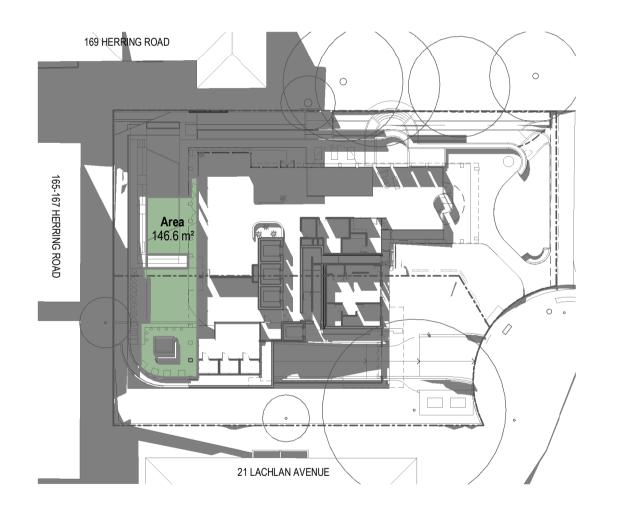

JUNE 21 - 11AM

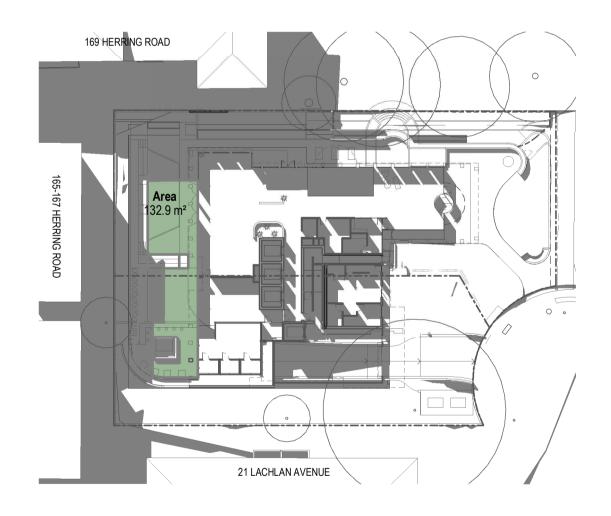

JUNE 21 - 11:30AM

Hour	Area	%
0900	54.4 m <sup>2</sup>	0.25
0915	115.6 m <sup>2</sup>	0.54
0930	112.6 m <sup>2</sup>	0.52
1000	133.1 m <sup>2</sup>	0.62
1100	146.6 m²	0.68
1130	132.9 m²	0.62
1200	117.0 m <sup>2</sup>	0.54
1215	109.2 m <sup>2</sup>	0.51
1230	84.7 m <sup>2</sup>	0.39
1300	53.7 m <sup>2</sup>	0.25
1400	27.2 m <sup>2</sup>	0.13
1500	13.0 m <sup>2</sup>	0.06


NOTE: BASED OFF COMMUNAL SPACE AREA OF 216m<sup>2</sup>

Revisions A 09.04.2021 DA SUBMISSION B 24.08.2021 DA SUBMISSION RFI RESPONSE

LACHLAN AVENUE


COMMUNAL SPACE SOLAR ACCESS SHEET 01

Project No 219099 Date 24.08.2021 Author KW Scale: @ A1 1:500 Drawing No. -

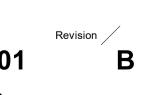





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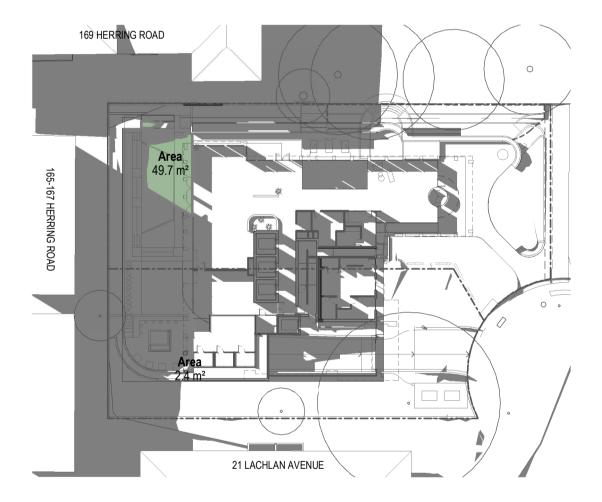
JUNE 21 - 12PM

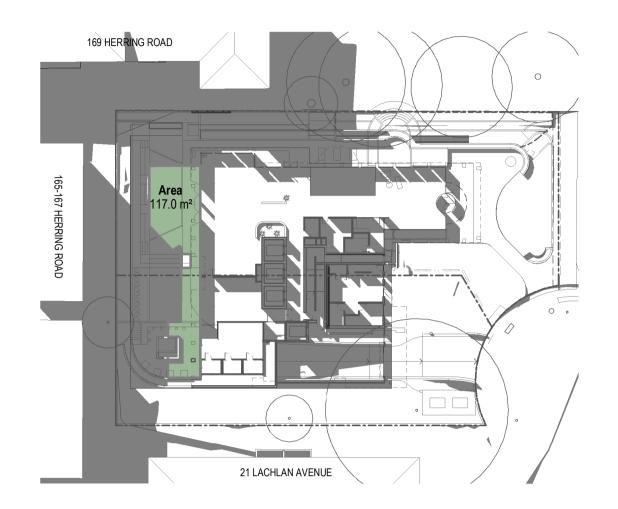


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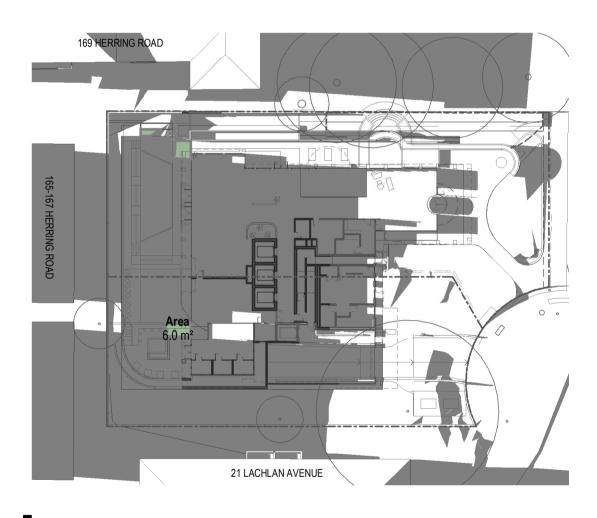
JUNE 21 - 12:30PM

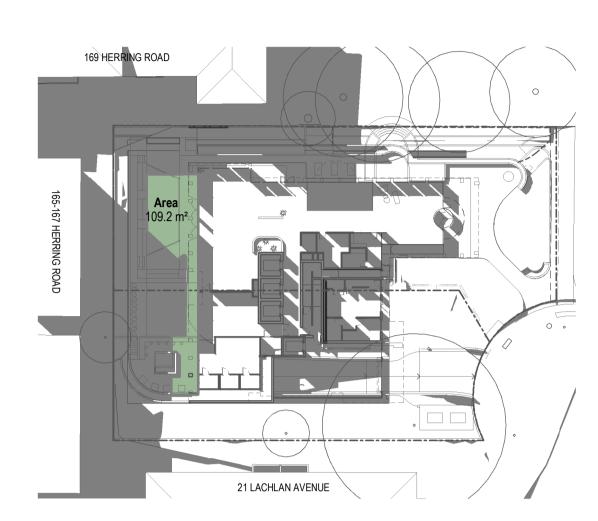

JUNE 21 - 1PM

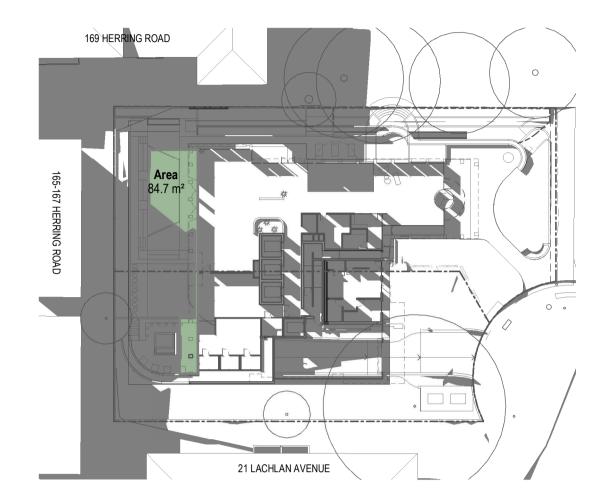

JUNE 21 - 2PM

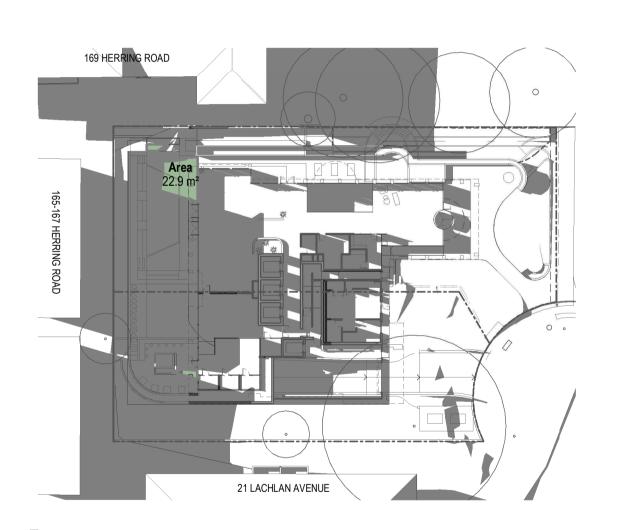

JUNE 21 - 3PM

Hour	Area	%
0900	54.4 m²	0.25
0915	115.6 m²	0.54
0930	112.6 m²	0.52
1000	133.1 m <sup>2</sup>	0.62
1100	146.6 m²	0.68
1130	132.9 m²	0.62
1200	117.0 m <sup>2</sup>	0.54
1215	109.2 m <sup>2</sup>	0.51
1230	84.7 m <sup>2</sup>	0.39
1300	53.7 m <sup>2</sup>	0.25
1400	27.2 m²	0.13
1500	13.0 m <sup>2</sup>	0.06

NOTE: BASED OFF COMMUNAL SPACE AREA OF 216m<sup>2</sup>

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LACHLAN AVENUE

23-25 LACHLAN AVENUE, MACQUARIE PARK

COMMUNAL SPACE SOLAR ACCESS SHEET 02





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# MF01

**MF02** 

Finish

**MF03** 

Location

Metal Finish - Bronze

Metal Finish - Light


Spandrel Panels

Typical Spandrel Head Panel, Window Frames in recessive elements.

Typical Slab Edge Panels and

Metal Finish - Light Bronze

Slab Edge/ Spandrel Panels

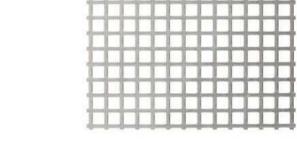

**MF07** 

Perforated Steel Mesh

Location Carpark Entry Walls



Finish Glazing - Clear

Location Windows level 2-14



## **GT02**

Finish Glazing - Clear

Location Windows - Basement Mezzanine, Ground Levels



# **MF04**

Metal Finish - Medium Bronze

Location Lower Level Slab Edge Panels and Spandrel Panels



Metal Finish - Light Grey

Location Window Frames



## AF01

**Finish** Paint - Light Grey

Location External Walls



# AF02

Finish Paint - White


Location Column End Face



## AF03

Finish Paint - Light Bronze

Location Column Side Face

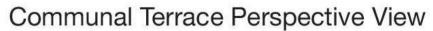

# DEVELOPMENT APPLICATION

Typical Facade Perspective View

Revisions A 09.04.2021 DA SUBMISSION

PERSPECTIVE VIEWS FOR INFORMATION ON MATERIALS / FINISHES ONLY. REFER TO FACADE SECTION DRAWING FOR DETAILED FACADE INFORMATION

**LACHLAN AVENUE** 

219099 Date 09.04.2021 KW Scale: @ A1 1: 100 TP11.01





#### **Community Facilities**

To create a modern student college, the provision of communal area is crucial to the social and civid dynamic of the residents

The proposed "Wrap" student housing focuses significant effort on the quality of these spaces, along with the management processes to amplify their useage.

The aim of these spaces is to draw students out of their private rooms, and to congregate together and get the full advantage of the student experience. This is how a successful college for learning is created.

The sites location and use as student accomodation, provides a rare opportunity to highly activate the public domain on two side of the site. One the street edge to Lachlan Avenue, the second being interfacing to the Elouera Reserve Parklands.


The communal areas have been positioned both partially above, and partially below ground in order to take advantage of the North-Eastern aspect the park provides, but to also animate this frontage as much as possible.

Communal areas visually and spatially connect to the outdoors throughout the project, mirroring internal uses, with a parallel external use. From private study spaces in the rear landscape setback, to public meeting areas adjacent the laneway, the ground plane seeks to maximise the landscape character of Macquarie Park, and embrace it in the new higher density format.

All Communal spaces at both ground, and upper levels receive high levels of solar access and aspect, with oppportunities for shade in summer, and passive heating in winter.

Providing the heart of the Student College, the communal areas at 23-25 Lachlan Avenue perform not only an important function for the residents of the building, but also for the benefit that they offer the locality.

#### 4.0 Design Proposal / 4.05 Community Facilities

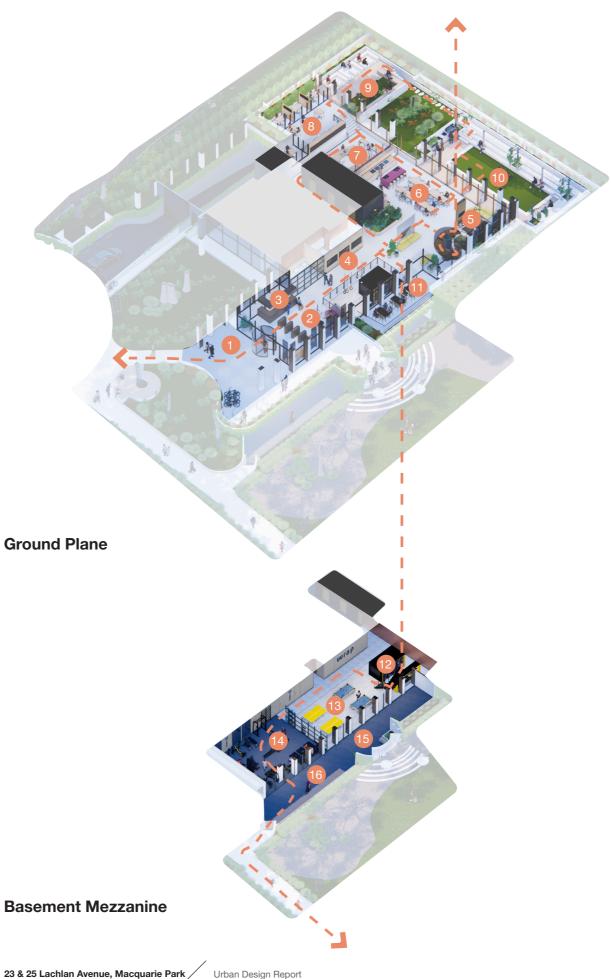

- Entry/Forecourt
- Foyer/Waiting
- Reception/Office
- Media/Digital Screens
- Lounge
- Kitchen/Dining
- Casual Study & Media
- Quiet Study & Pods
- **Outdoor Study**
- Communal Courtyard
- Outdoor Seating/Dining Area
- Laundry
- Games Lounge
- Gym
- Grotto
- Outdoor Gym

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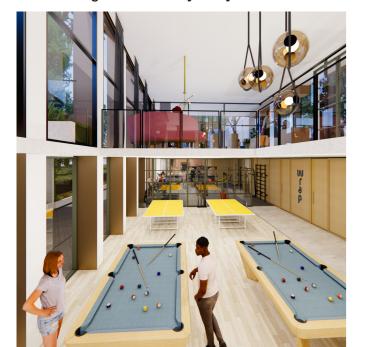
#### **Ground Floor Communal Areas**

Creating a visually prominent address to Lachlan Avenue, the pedestrian pathway, and the park itself, the ground floor communal areas create a more vibrant public domain adjacent the site and allow for residents to interact with leach other in a high quality environment.

Internal spaces throughout create visual connection to the landscape beyond in order to make the development aligned to the vision for Macquarie Park.



Main Waiting area and entry lobby



North facing double height space adjacent entry with Gym beyond





Laundry and Games room facing park




Student Lounge



Rear courtyard looking south

#### **Natural Ventilation**

To increase the amenity and comfort of the students, all bedrooms have access to natural ventilation via an awning window. This allows for students to regulate the amount of ventilation as they desire.

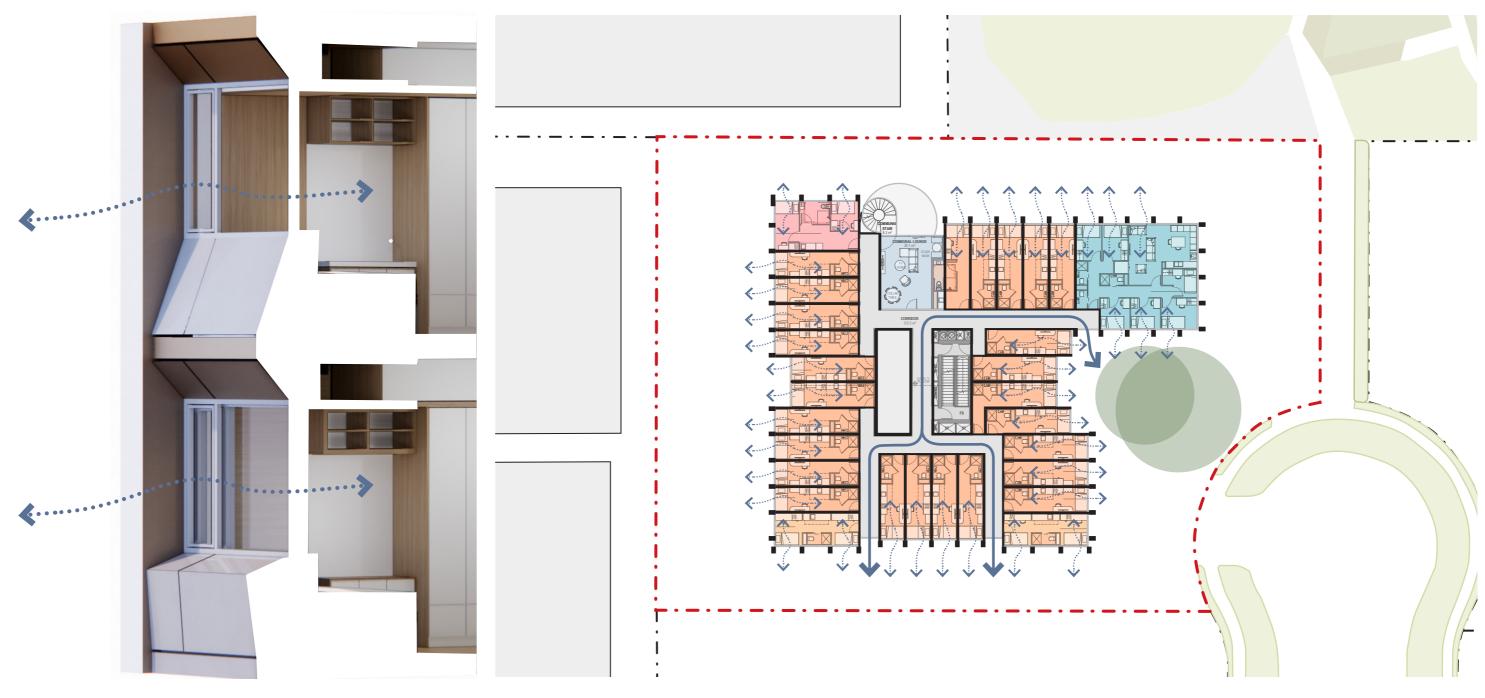


**Typical Facade Axonometric** 


Typical Tower Level Plan Diagram

### Single Studio


The Single Studio is the typical accommodation option. All dwellings are equipped with a private en-suite, a kitchenette and a study desk, with built in shelving and storage, allowing for privacy as necessary.



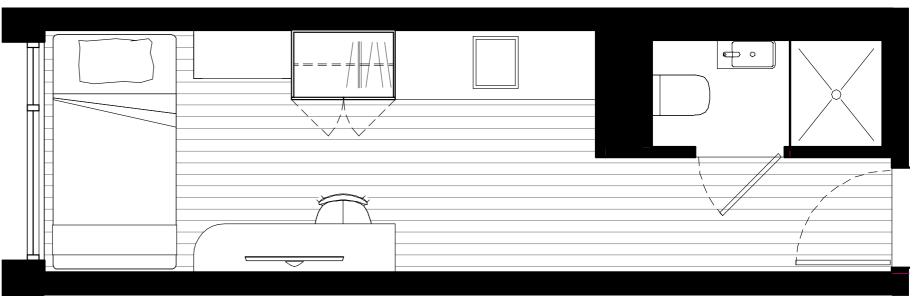

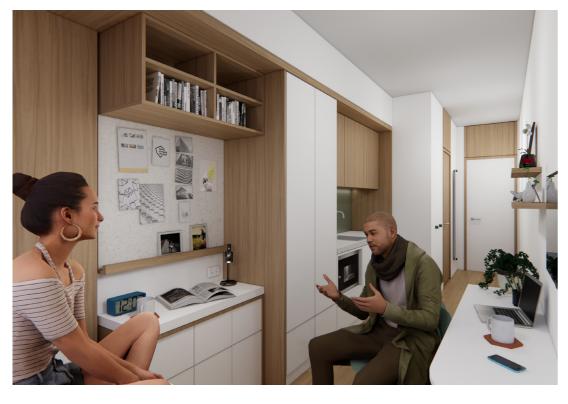



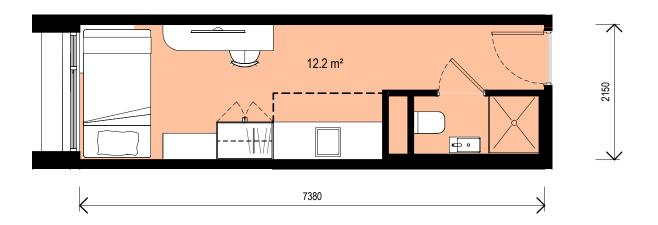

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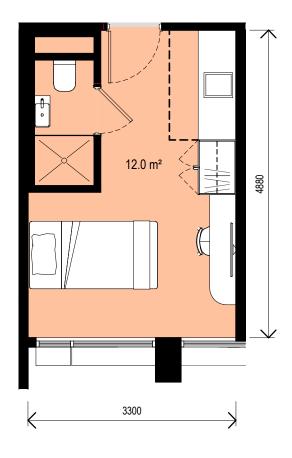
LACHLAN AVENUE

SINGLE STUDIO TYPE

Project No 219099 Date 14.04.2022 Author KW Scale: @ A3 1 : 60 TP13.01 B



23-25 LACHLAN AVENUE, MACQUARIE PARK



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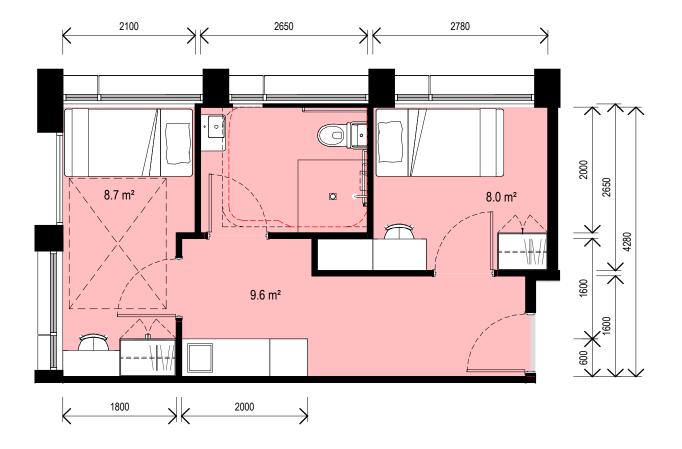
LACHLAN AVENUE

SINGLE STUDIO TYPE





23-25 LACHLAN AVENUE, MACQUARIE PARK



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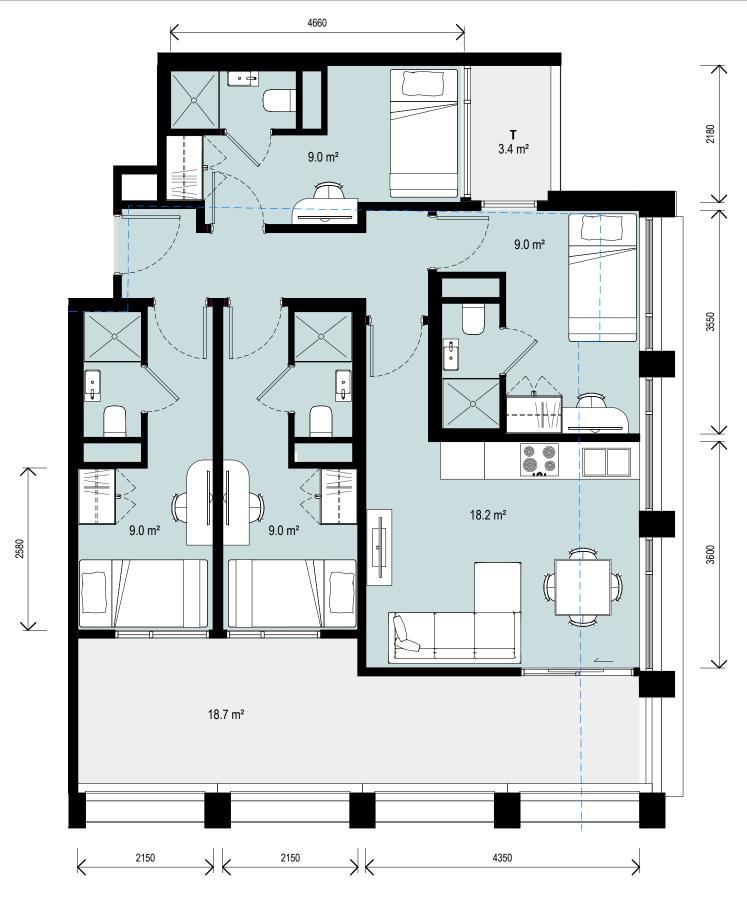
Revisions A 24.08.2021 DA SUBMISSION RFI RESPONSE KW
B 14.04.2022 DA SUBMISSION RFI RESPONSE BR

LACHLAN AVENUE

2 BED APARTMENT

Project No 219099 Date 14.04.2022 Author SJ Scale: @ A3 1:60 TP13.04 B





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LACHLAN AVENUE

4 BED APARTMENT

Project No 219099 Date 14.04.2022 Author SJ Scale: @ A3 1 : 60 TP13.05 B





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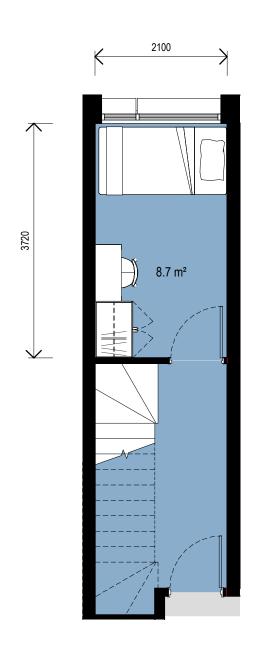
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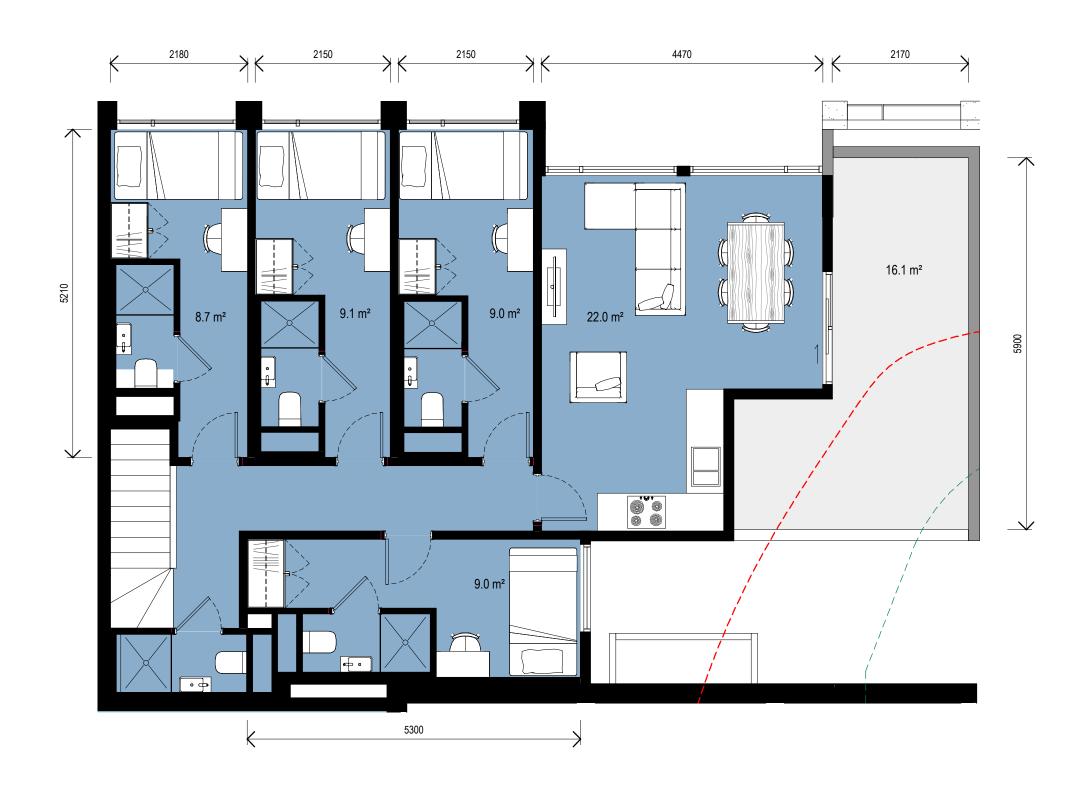
LACHLAN AVENUE

5 BED APARTMENT

Project No 219099 Date 14.04.2022 Author SJ Scale: @ A3 1 : 60 TP13.06 B







LOWER

UPPER

# **DEVELOPMENT APPLICATION**

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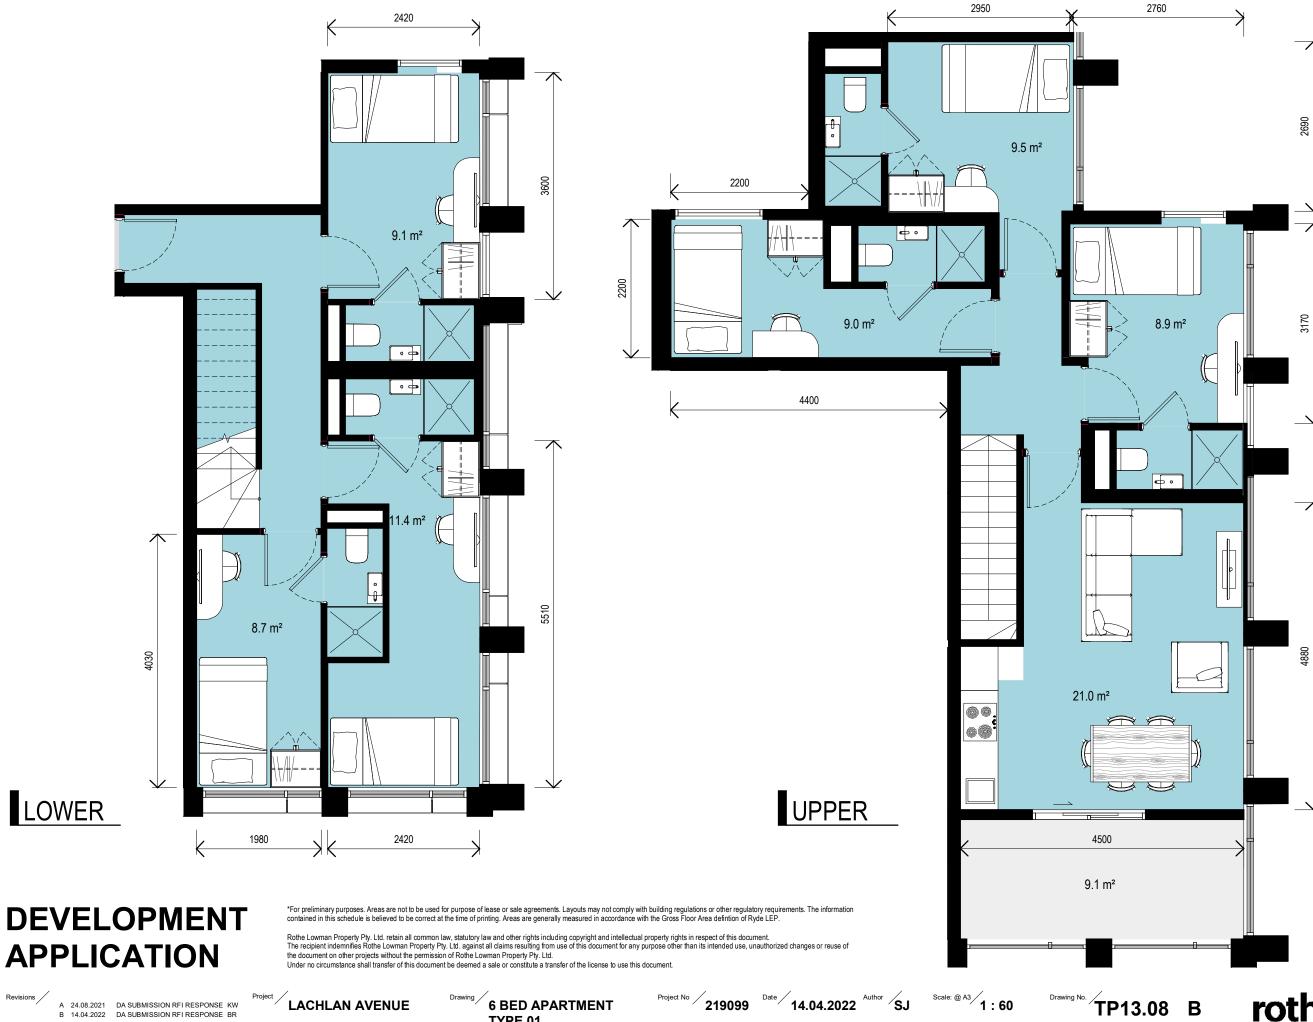
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LACHLAN AVENUE

5 BED APARTMENT

Project No 219099 Date 14.04.2022 Author SJ Scale: @ A3 1 : 60 TP13.07 B






**DEVELOPMENT** 

A 24.08.2021 DA SUBMISSION RFI RESPONSE KW B 14.04.2022 DA SUBMISSION RFI RESPONSE BR



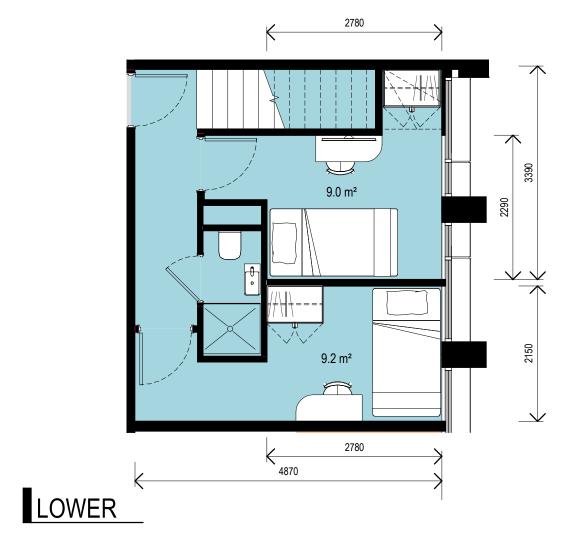



A 24.08.2021 DA SUBMISSION RFI RESPONSE KW B 14.04.2022 DA SUBMISSION RFI RESPONSE BR

contained in this schedule is believed to be correct at the time of printing. Areas are generally measured in accordance with the Gross Floor Area definition of Ryde LEP.


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LACHLAN AVENUE

6 BED APARTMENT

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JUNE 21 - 10AM JUNE 21 - 9AM

# **DEVELOPMENT APPLICATION**


A 09.04.2021 DA SUBMISSION
B 24.08.2021 DA SUBMISSION RFI RESPONSE
C 04.05.2022 DA SUBMISSION RFI RESPONSE KW KW JC

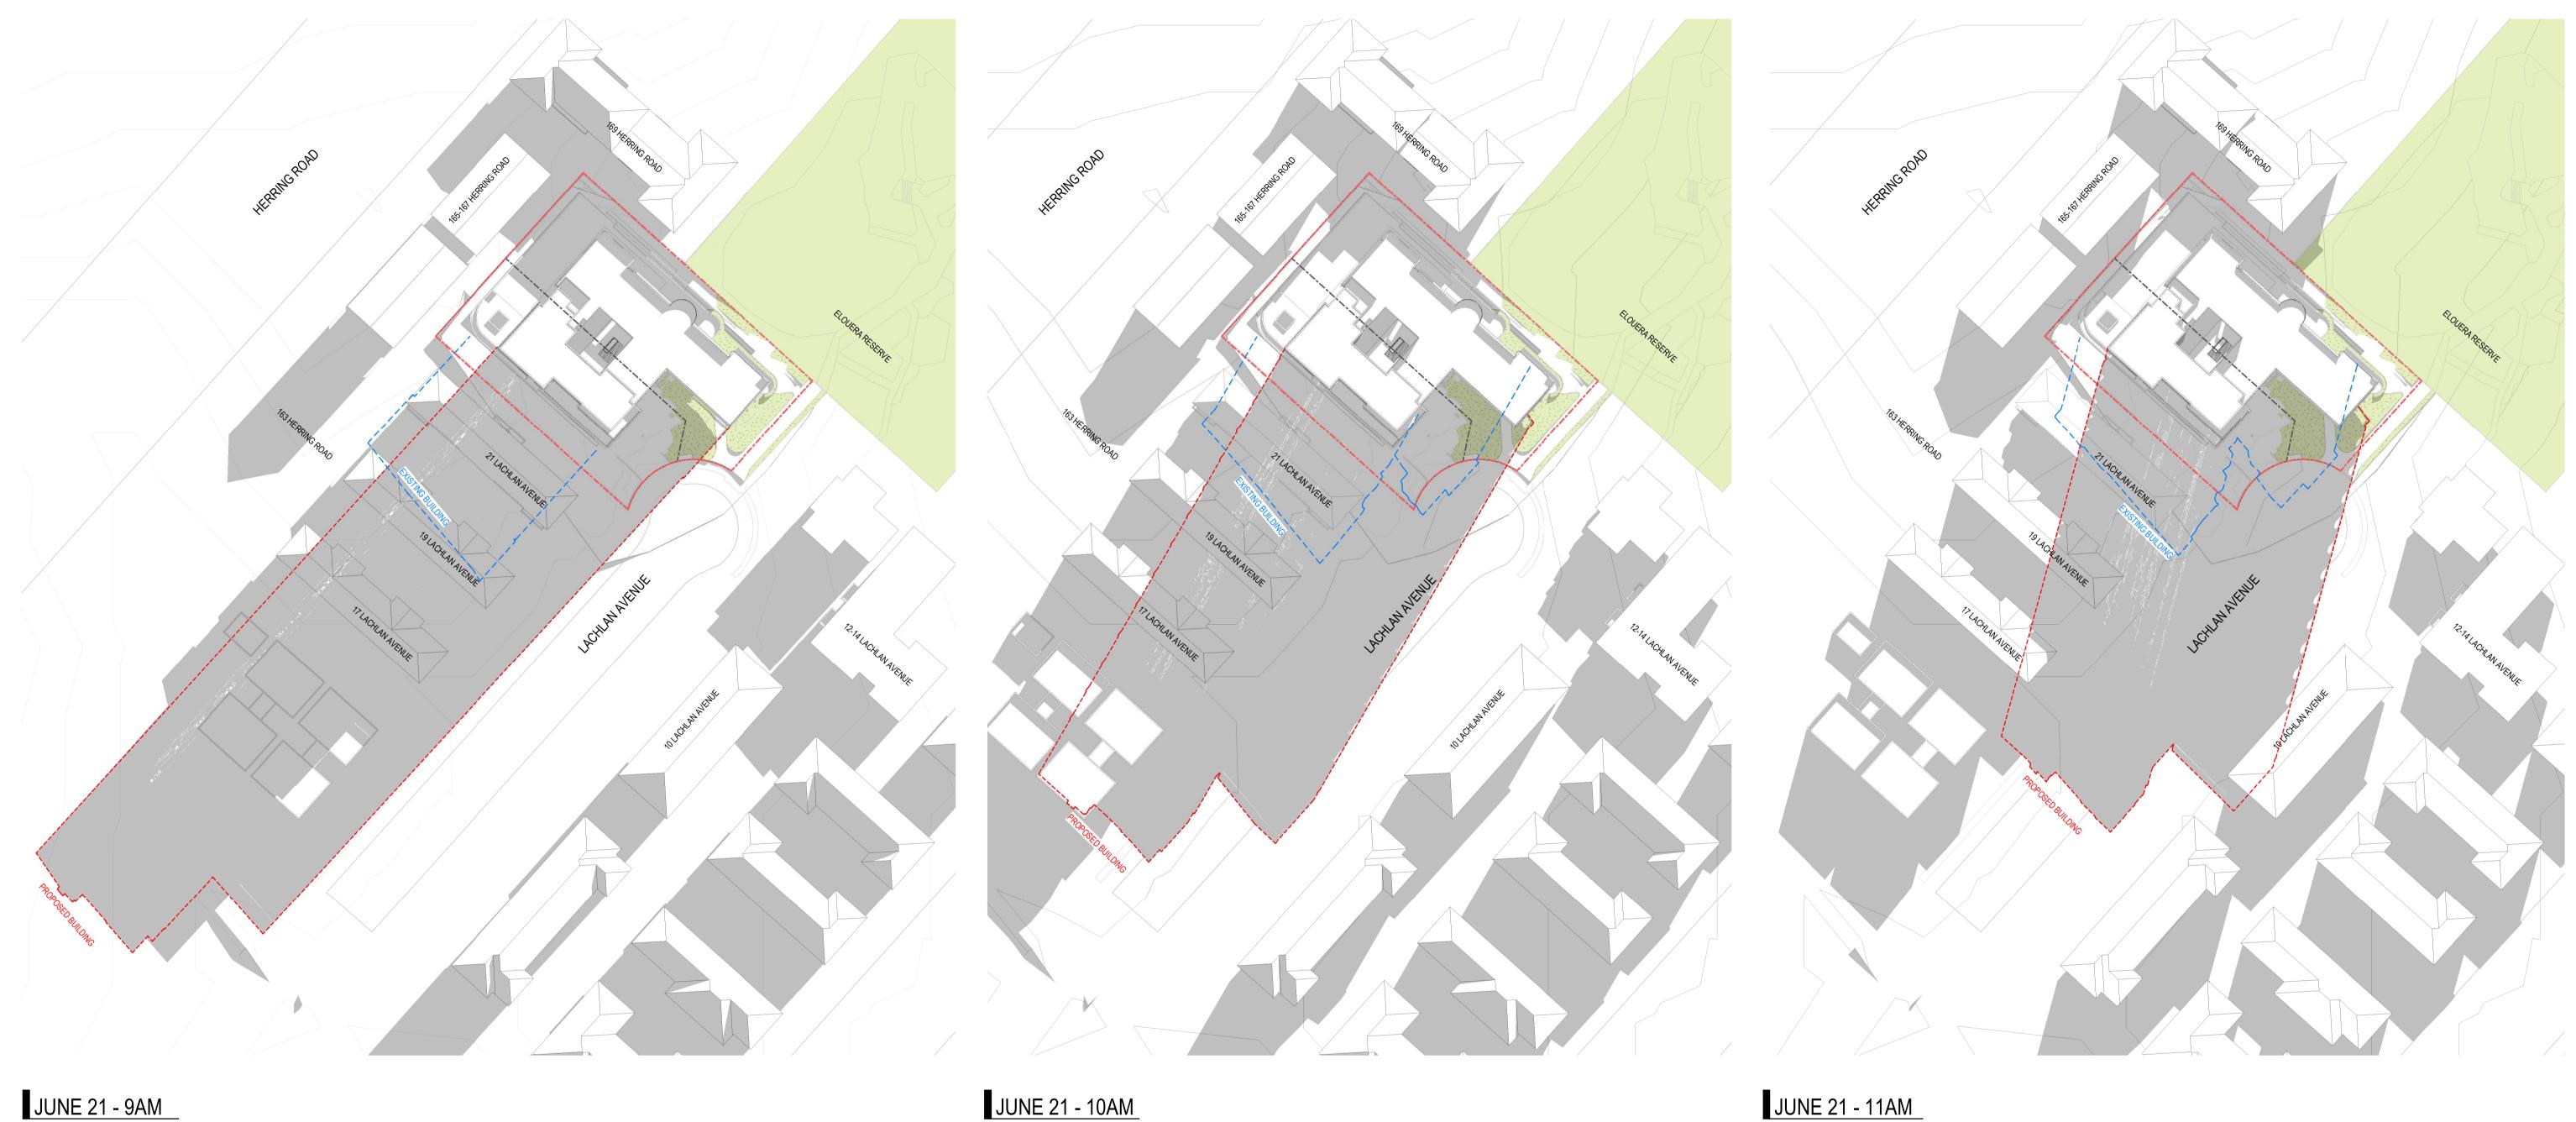LEGEND ---- SHADOW CAST ON GROUND PLANE BY PROPOSED BUILDING SHADOW CAST ON GROUND PLANE BY EXISTING NEIGHBOURING BUILDINGS LACHLAN AVENUE

23-25 LACHLAN AVENUE, MACQUARIE PARK

SHADOW DIAGRAMS
PLAN VIEW

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Revisions A 09.04.2021 DA SUBMISSION KW
B 24.08.2021 DA SUBMISSION RFI RESPONSE KW
C 04.05.2022 DA SUBMISSION RFI RESPONSE JC

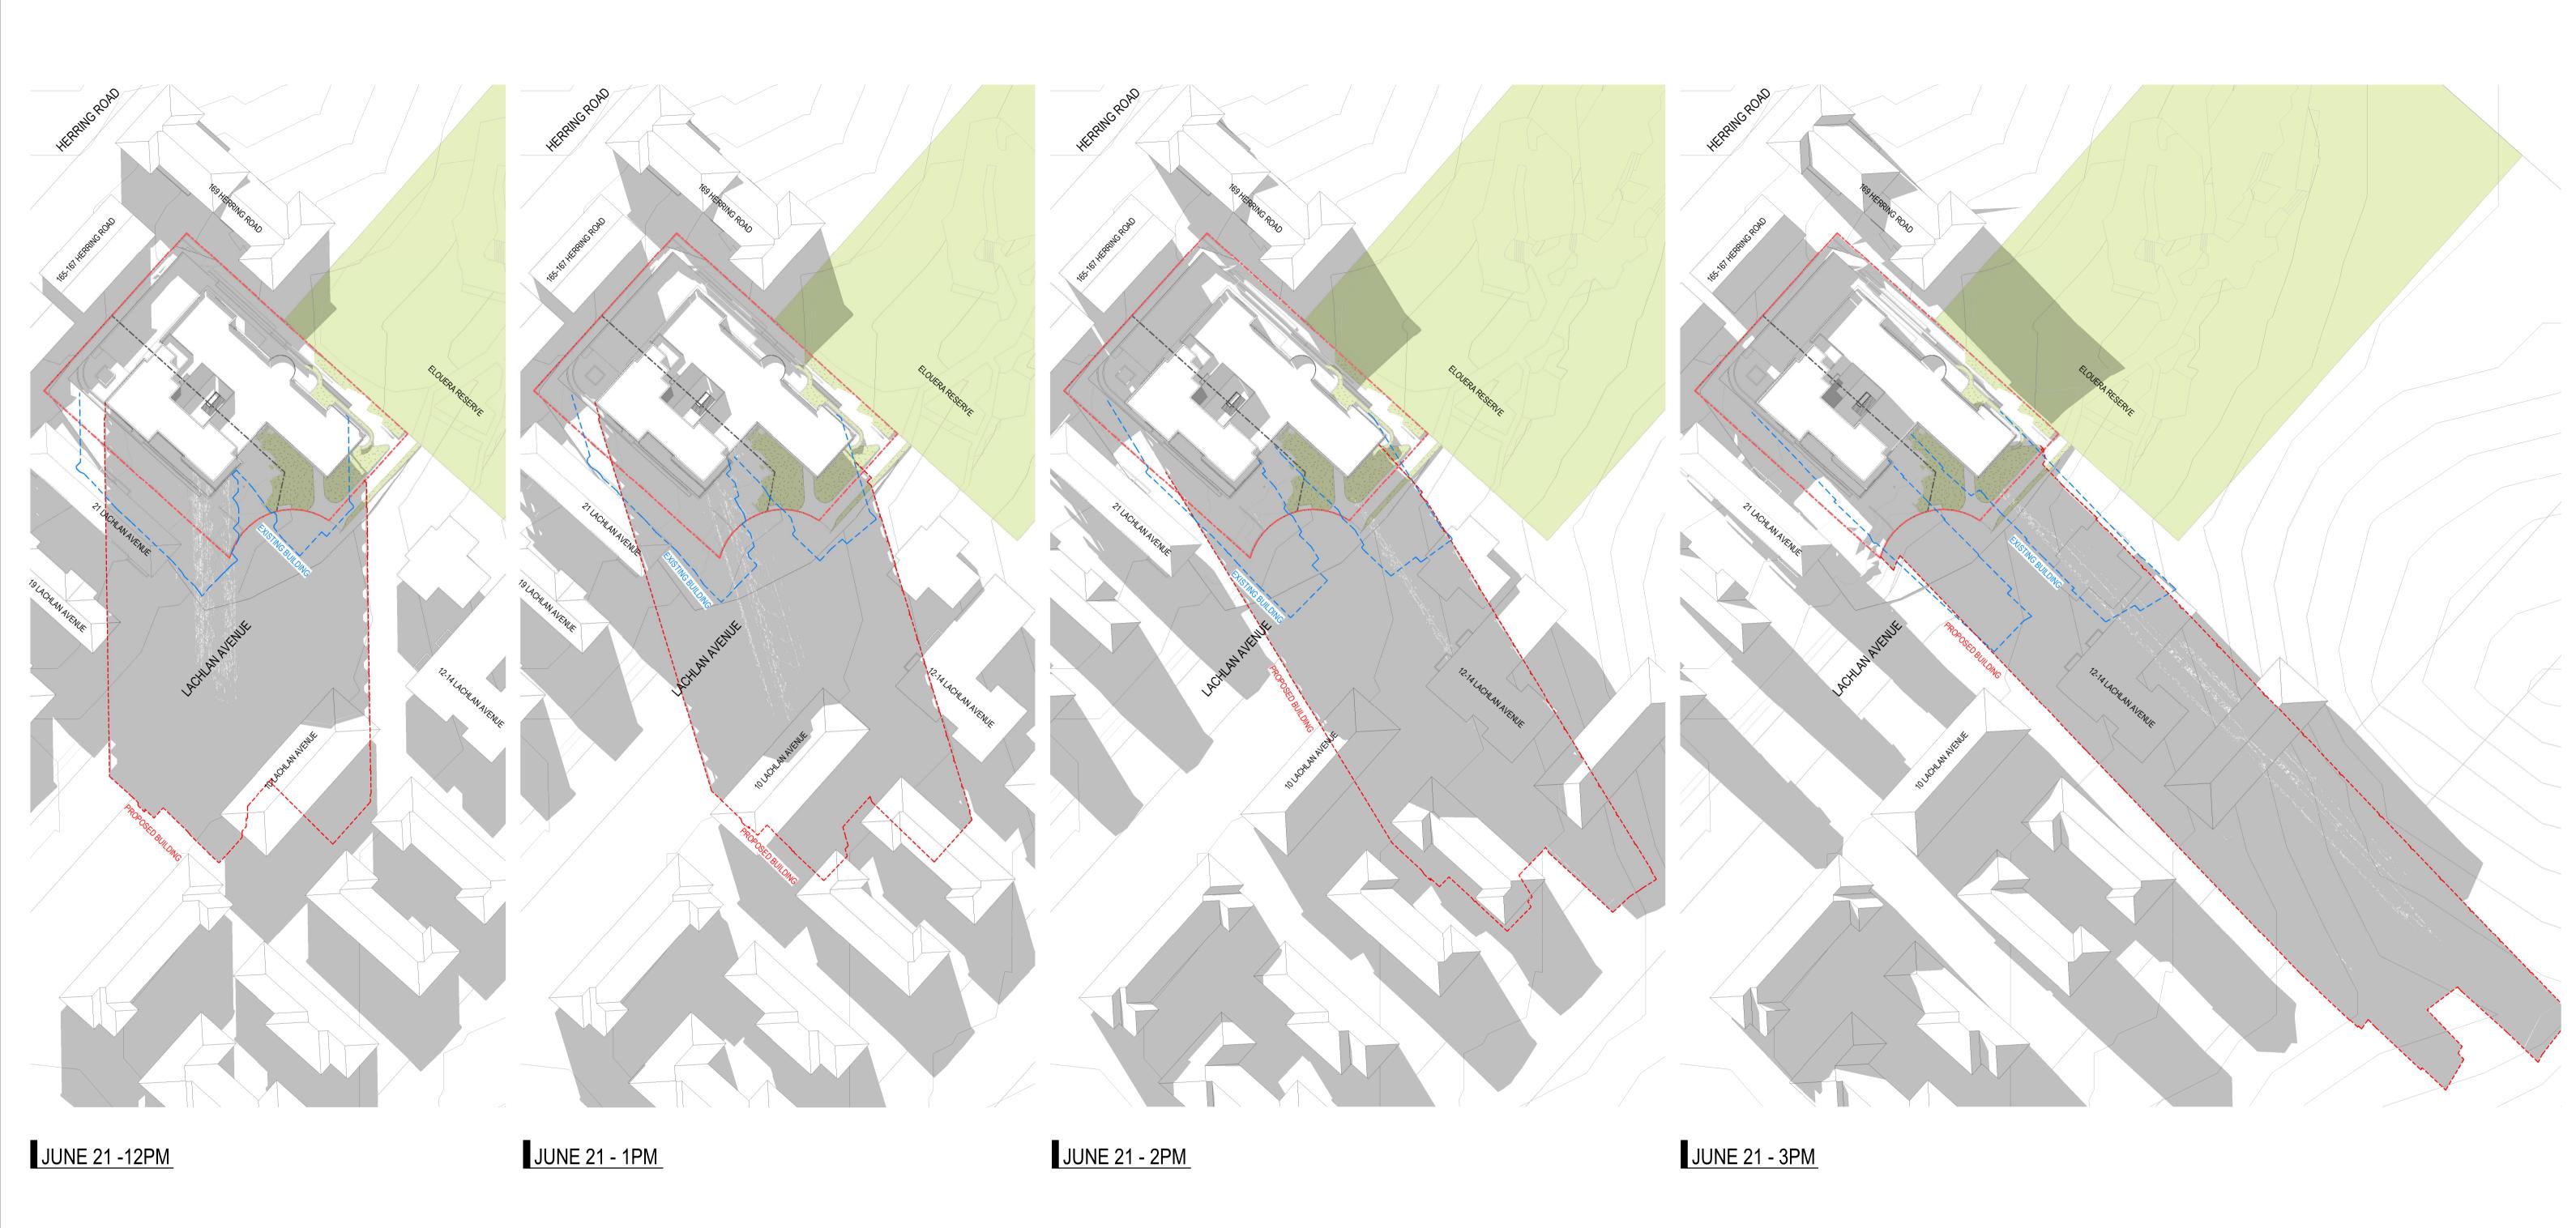LEGEND

---- SHADOW CAST ON GROUND PLANE BY PROPOSED BUILDING

---- SHADOW CAST ON GROUND PLANE BY EXISTING NEIGHBOURING BUILDINGS

LACHLAN AVENUE

23-25 LACHLAN AVENUE, MACQUARIE PARK

SHADOW DIAGRAMS
PLAN VIEW

219099 Date 04.05

Scale: @ A1 1: 600


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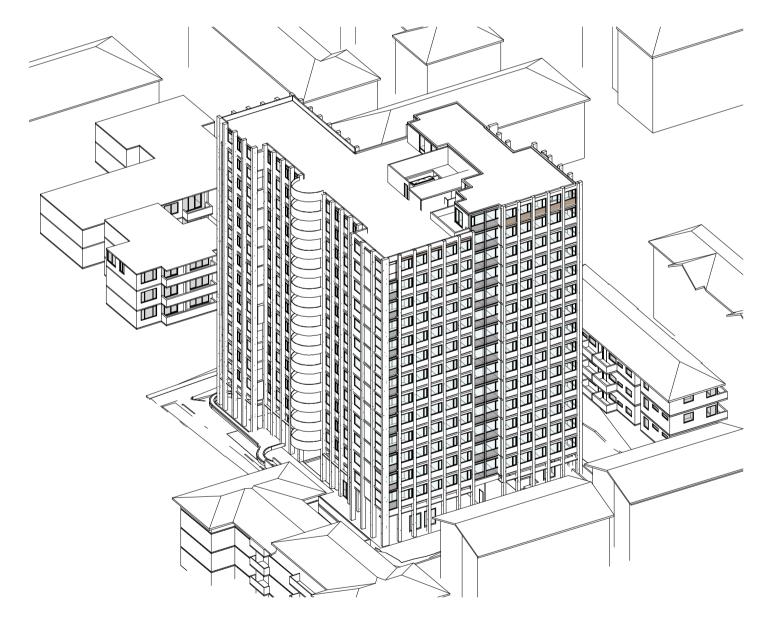
TP04.02 Revision C


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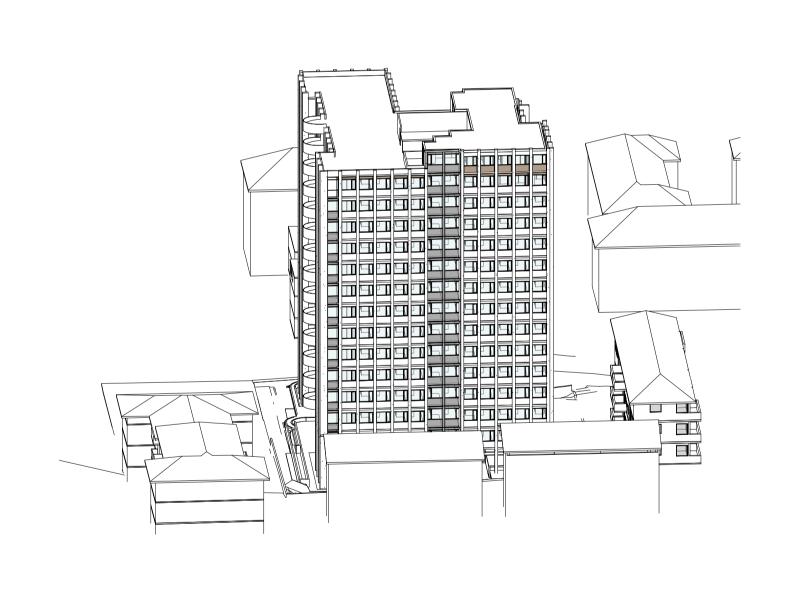
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JUNE 21 - 1PM

**DEVELOPMENT APPLICATION** 

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C 29.04.2022 DA SUBMISSION RFI RESPONSE JC

LACHLAN AVENUE

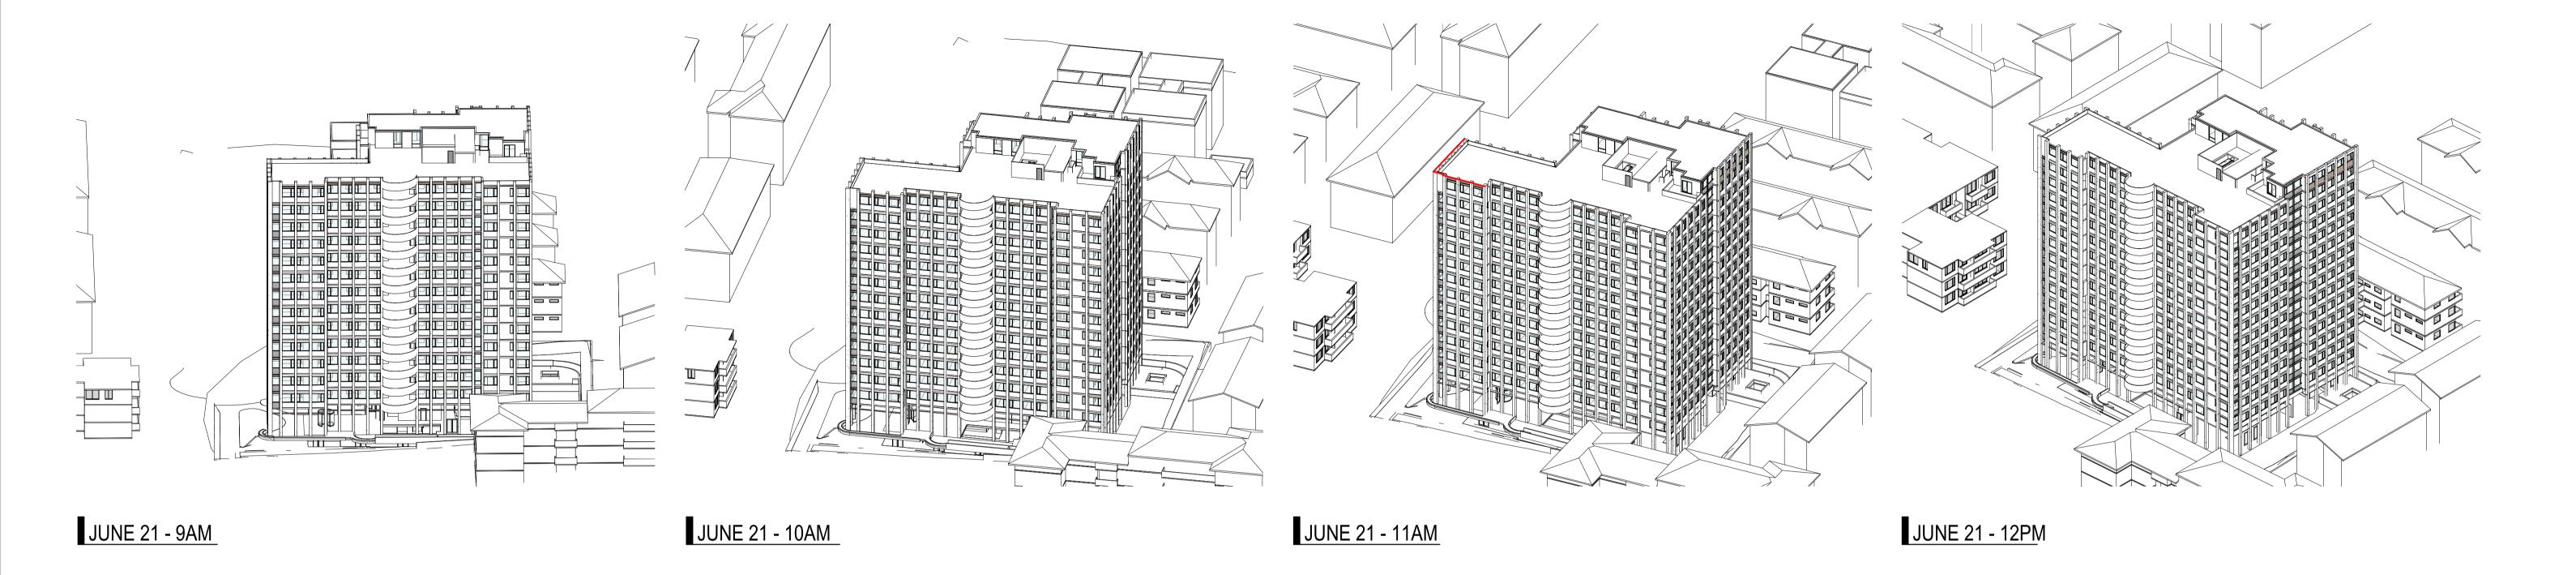23-25 LACHLAN AVENUE, MACQUARIE PARK

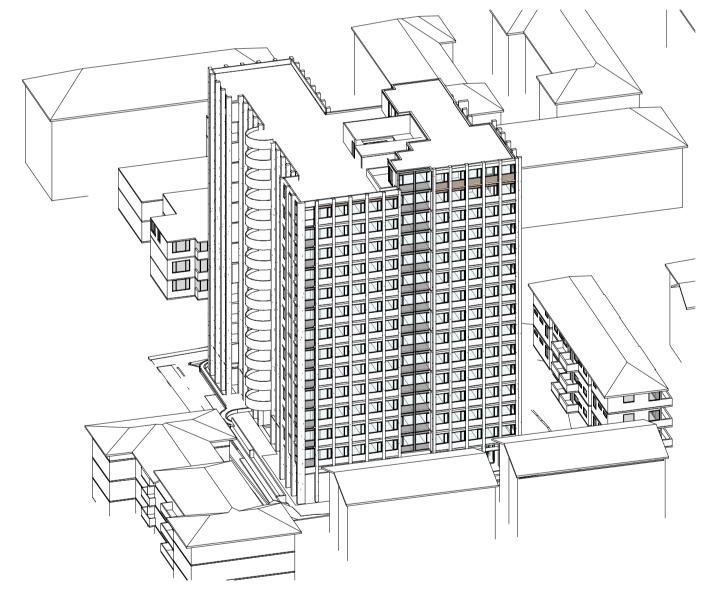
SHADOW DIAGRAMS 219099
POINT OF VIEW - JUNE


JUNE 21 - 3PM


29.04.2022 Author JC Scale:


Drawing No. Revision / TP04.03

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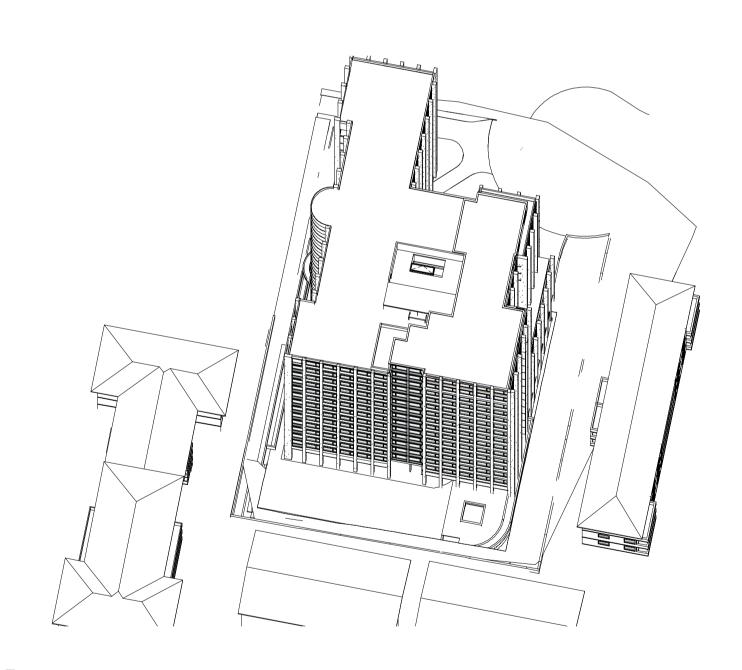


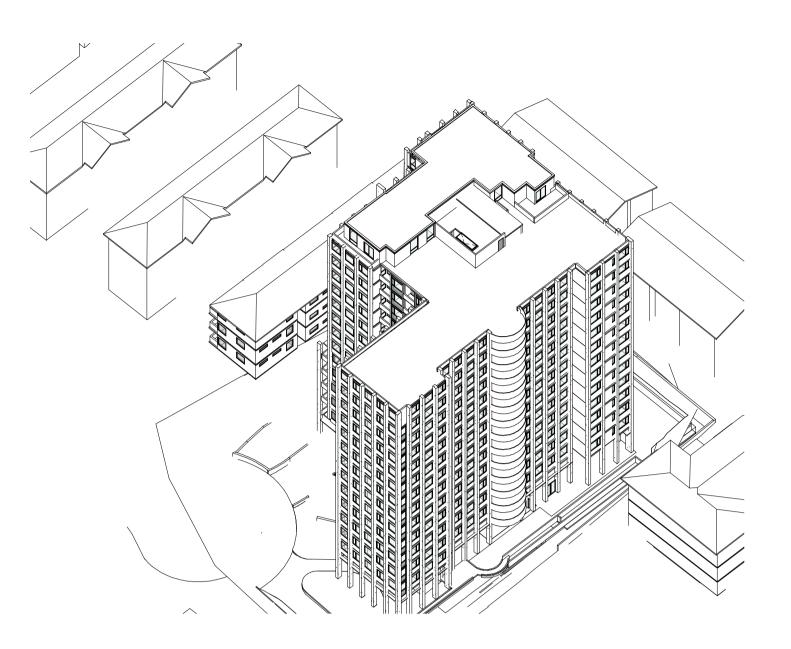DECEMBER 22 - 9AM

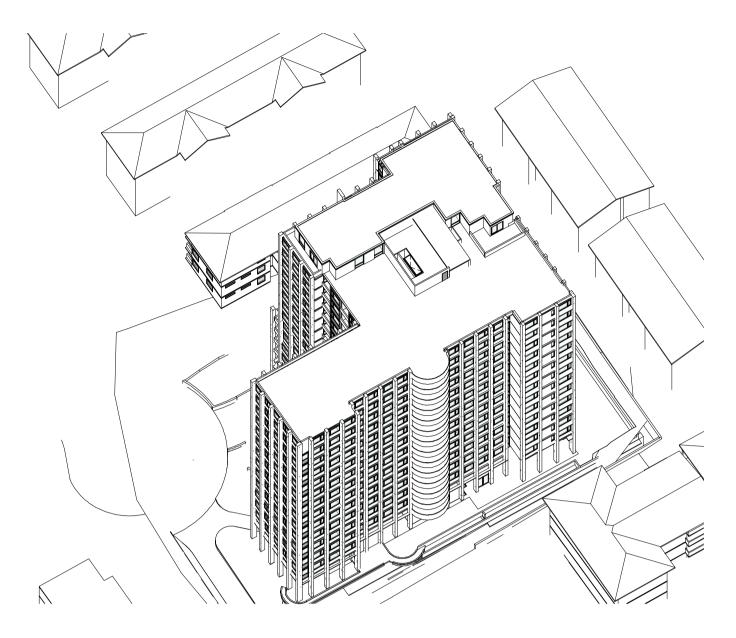
DECEMBER 22 - 10AM

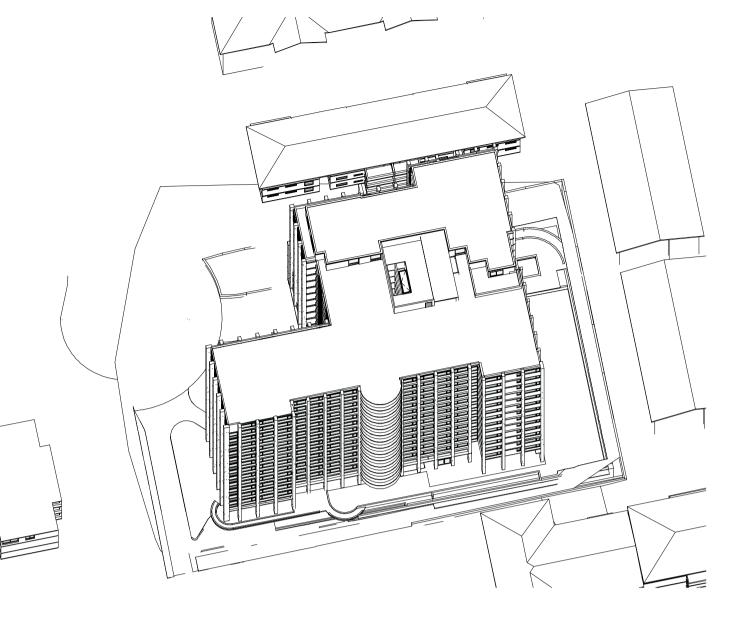DECEMBER 22 - 11AM

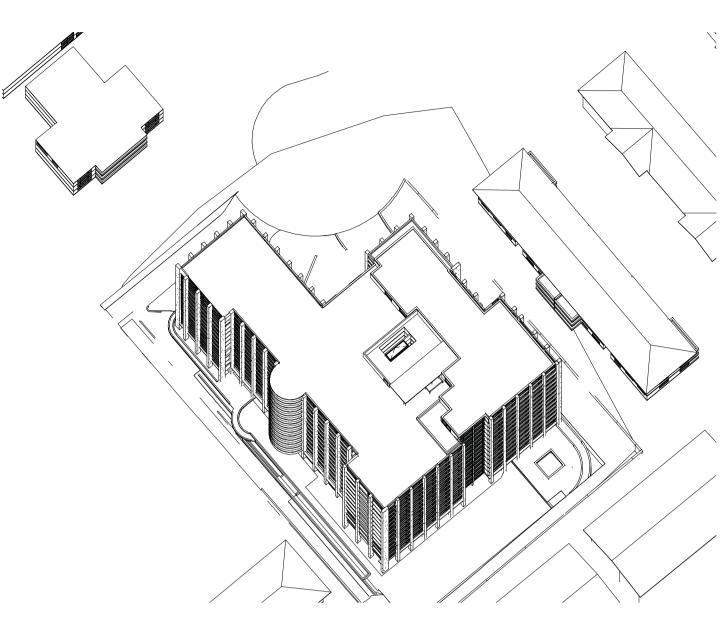DECEMBER 22 - 12PM





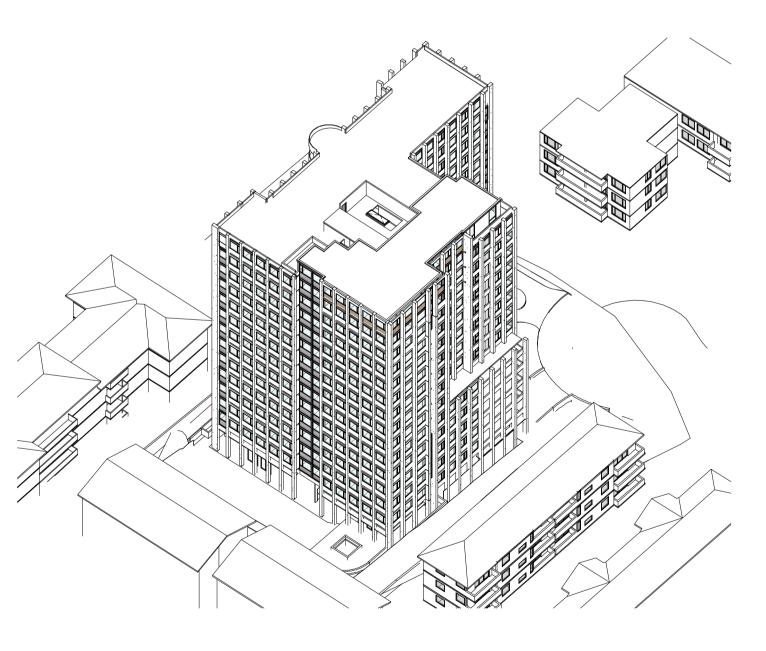

DECEMBER 22 - 1PM

DECEMBER 22 - 2PM

DECEMBER 22 - 3PM


09.04.2021 DA SUBMISSION 24.08.2021 DA SUBMISSION RFI RESPONSE 29.04.2022 DA SUBMISSION RFI RESPONSE


LACHLAN AVENUE

23-25 LACHLAN AVENUE, MACQUARIE PARK

SHADOW DIAGRAMS POINT OF VIEW -DECEMBER 22


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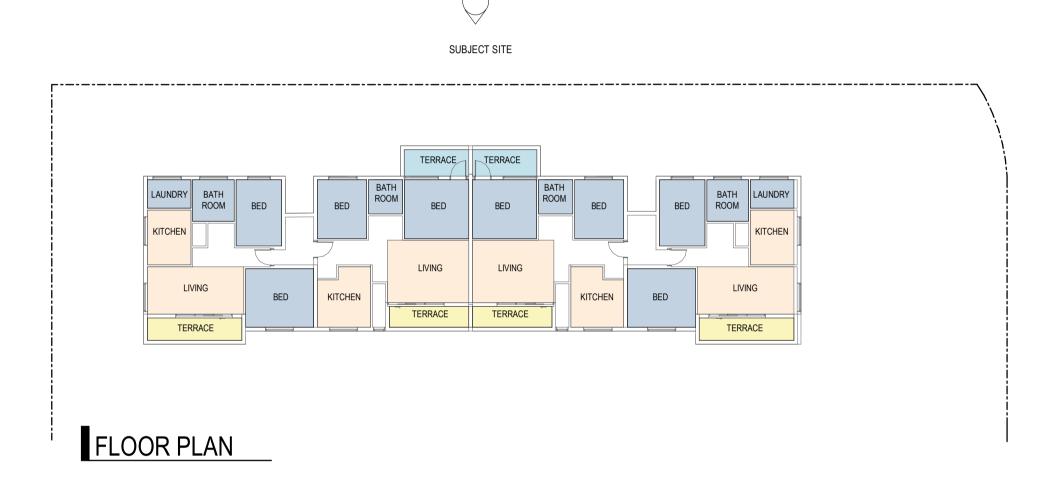
JUNE 21 - 9AM

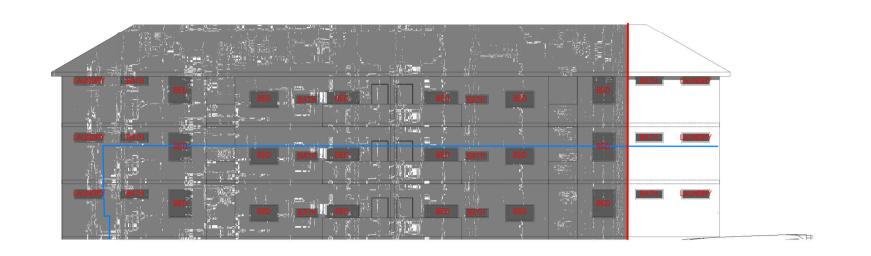
JUNE 21 - 10AM

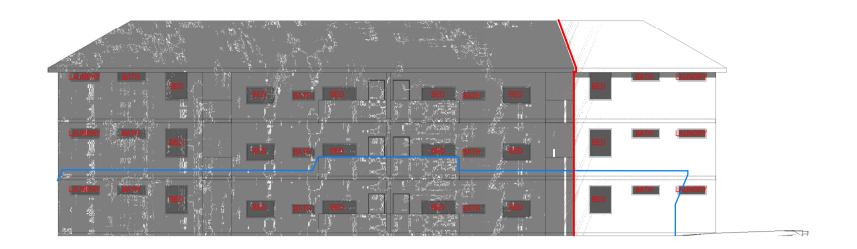



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JUNE 21 - 12PM



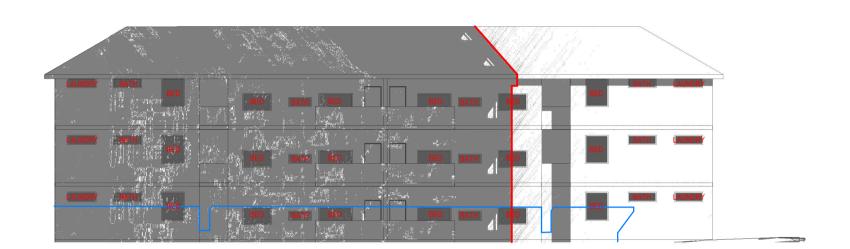

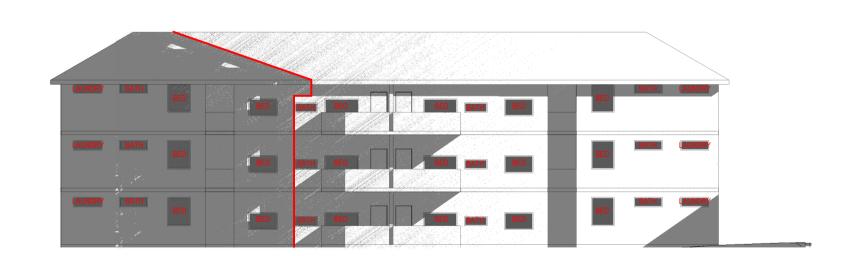

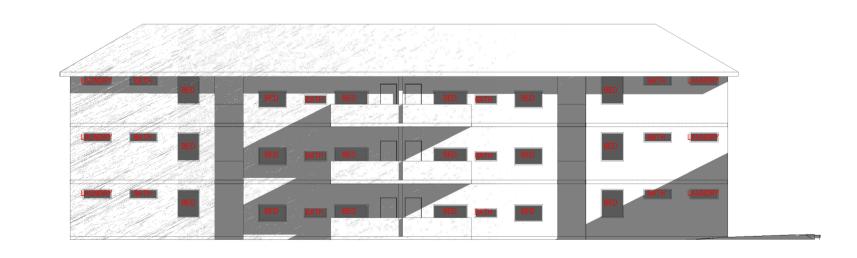

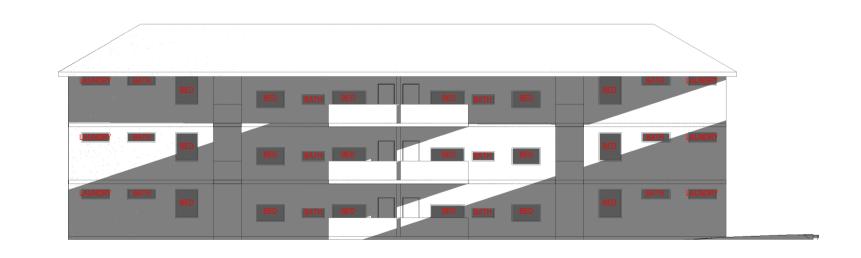JUNE 21 - 1PM

JUNE 21 - 2PM

JUNE 21 - 3PM


**DEVELOPMENT APPLICATION** 


Revisions
A 20.04.2021 DA SUBMISSION RFI RESPONSE
B 29.04.2022 DA SUBMISSION RFI RESPONSE

**LEGEND** EXISTING BUILDING — PROPOSED DEVELOPMENT LACHLAN AVENUE


ELEVATIONAL **SHADOW DIAGRAMS -**21 LACHLAN AVE 23-25 LACHLAN AVENUE, MACQUARIE PARK


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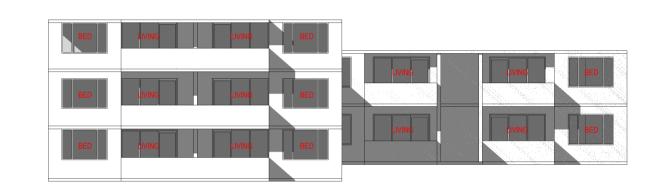


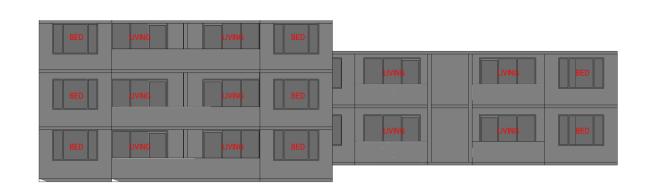

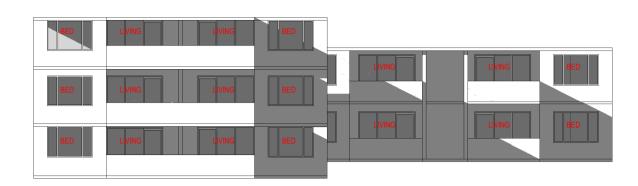JUNE 21 - 9AM



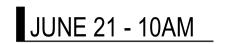

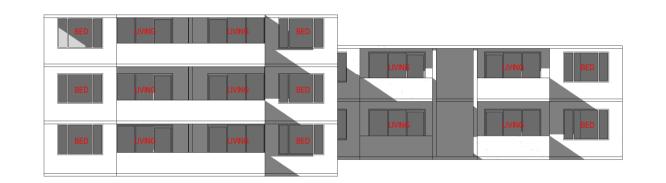






JUNE 21 - 11AM

JUNE 21 - 12PM

FLOOR PLAN

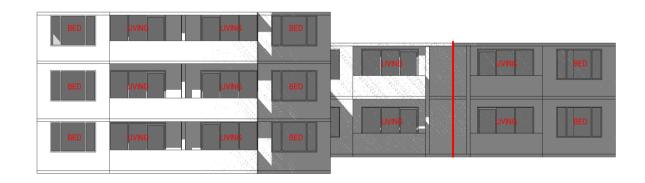

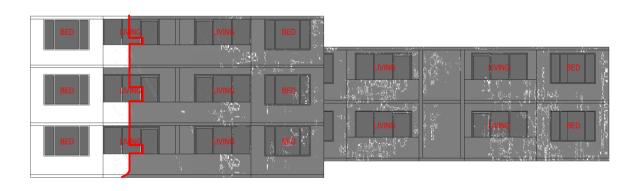

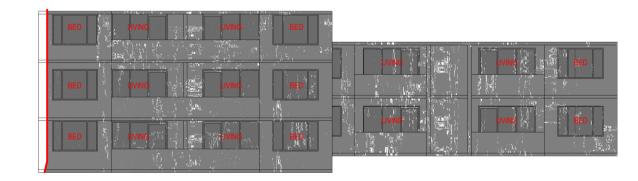

JUNE 21 - 1PM

JUNE 21 - 2PM

JUNE 21 - 3PM

Revisions
A 20.04.2021 DA SUBMISSION RFI RESPONSE
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**LEGEND** EXISTING BUILDING — PROPOSED DEVELOPMENT LACHLAN AVENUE

**ELEVATIONAL SHADOW DIAGRAMS -**12-14 LACHLAN AVE 23-25 LACHLAN AVENUE, MACQUARIE PARK

**TP04.06** 

To create an environment where students have the opportunity to have areas for both rest and recreation through out the external spaces via 2 distinctive zones, 1 for quiet outdoor study and the other to encourage social interaction and group gatherings with seating arrangements, bbq space and open lawn. The planting is to be predominantly native with careful consideration to shade tolerant species within the rear courtyard to accommodate the enclosed nature of the space. Visual connections to the neighbouring park are maintained while strong links are provided to Lachlan Ave for vehicles, pedestrian and cyclists.





social +





fun





Project /


North /

Prepared By / Client / Architect /

LandFX Landscape Architecture Barcam Mac Park Pty Ltd


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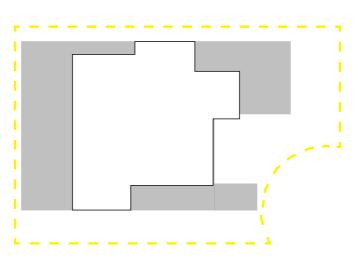
Constraint 01

Footprints

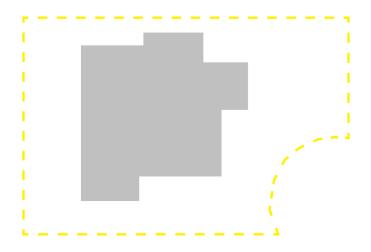


Opportunity 01

Visual connection to park

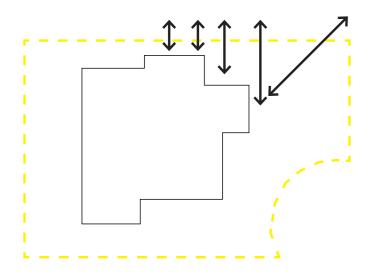


Constraint 02

**Basement Carparking Extents** 

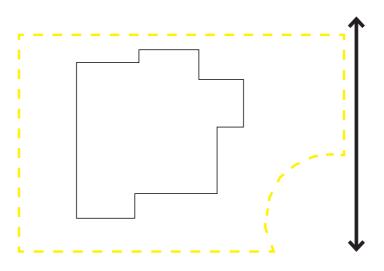


Opportunity 02

Connection to local links

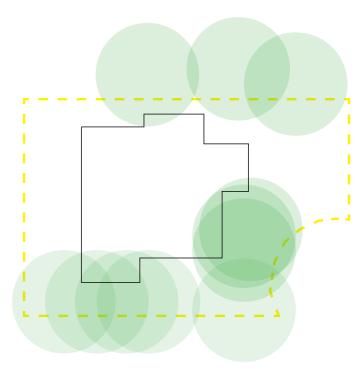

Constraint 03

Retaining existing trees

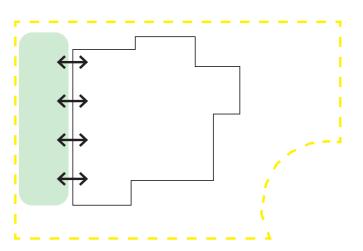

Opportunity 03

Indoor to Outdoor Amenity Flow




North /

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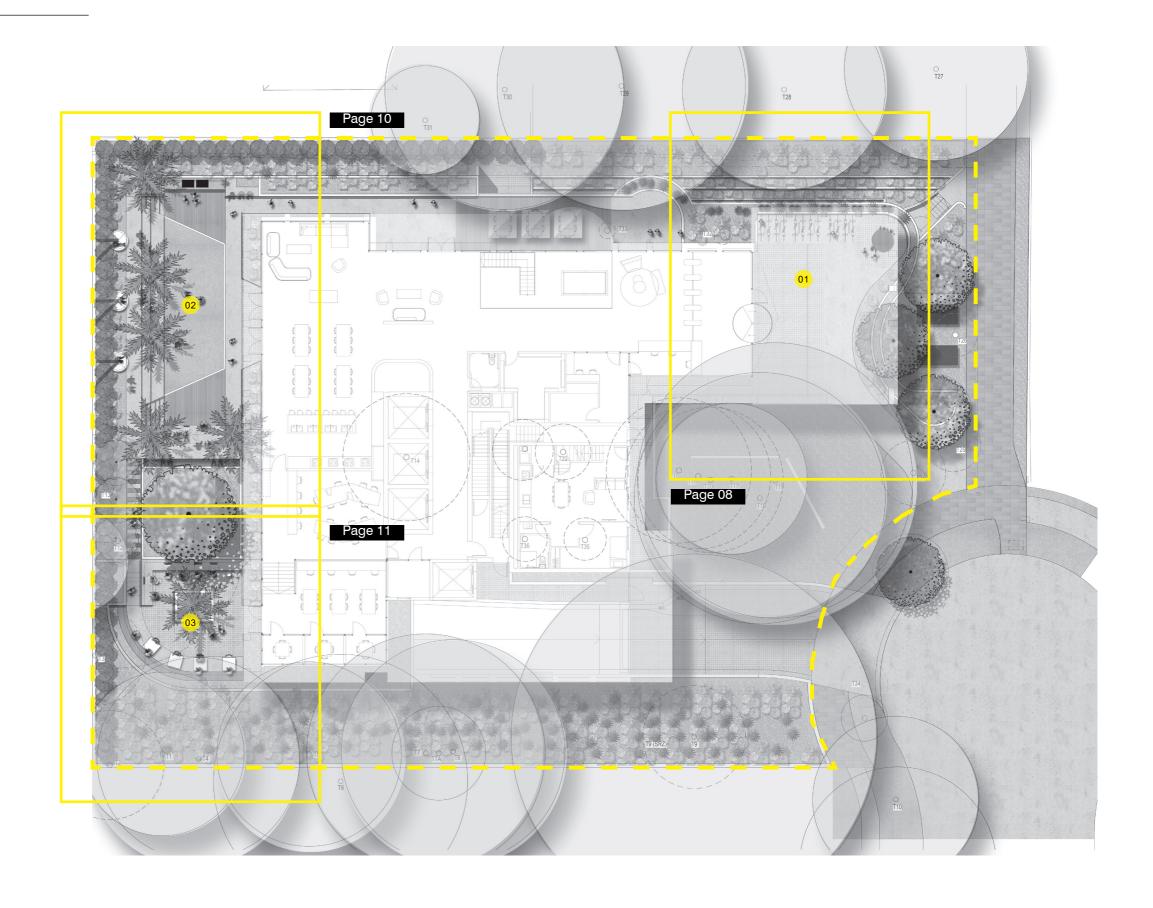
- Buffer planting to neighbouring properties
- Rear courtyard with the following amenities:
  - Open turf zone
  - BBQ
  - Seating steps
  - Circulation
  - Shade trees
  - Buffer planting to boundary edges
- Buffer planting between differing outdoor uses
- Outdoor study zone
- 5m setback to Southern Boundary with Existing trees retained
- Subject to Art Plan and Council Consultation
- Existing trees to be retained
- Upper plaza with seating, bicycle stands
- Widened public path link from Lachlan Ave to Elouera Park to be granite 'raven black' paver (Ryde DCP)
- Landscape berm with native planting mix
- Waiting / seating area
- Existing trees to be retained with improved understorey planting
- Footpath to be granite 'raven black' pavers (Ryde DCP)
- Basement entry
- Improved vehicle crossing
- Relocated substation
- Existing concrete footpath made good after construction
- Lighting along this section is to be consistent with the lighting within Elouera Reserve including pole colour and type and luminaire type.





### Legend

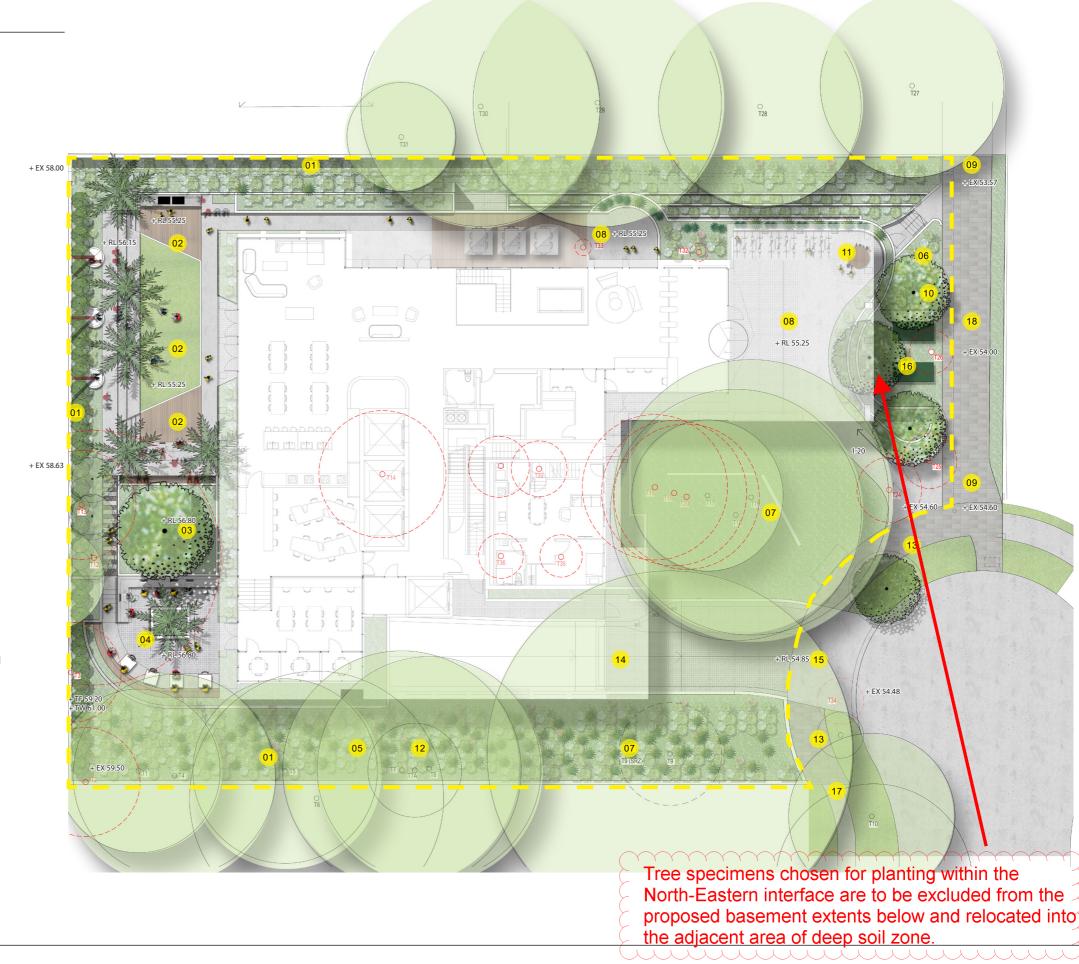- North Eastern Interface
- Rear Courtyard 1 of 2
- Rear courtyard 2 of 2





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Project / 23-25 LACHLAN AVE, MACQUARIE PARK, NSW 2123 LANDSCAPE DEVELOPMENT APPLICATION

### Structure Planting

All planting on top of podium will comply with Ryde City Council DCP Standards with drainage and waterproofing to Engineers Details.

Legend Planting Depths:


Planting type: Medium sized tree

Depth: 900mm

Planting type: Tree ferns and groundcovers

Depth: 500mm

Planting type: Shrubs and ground covers

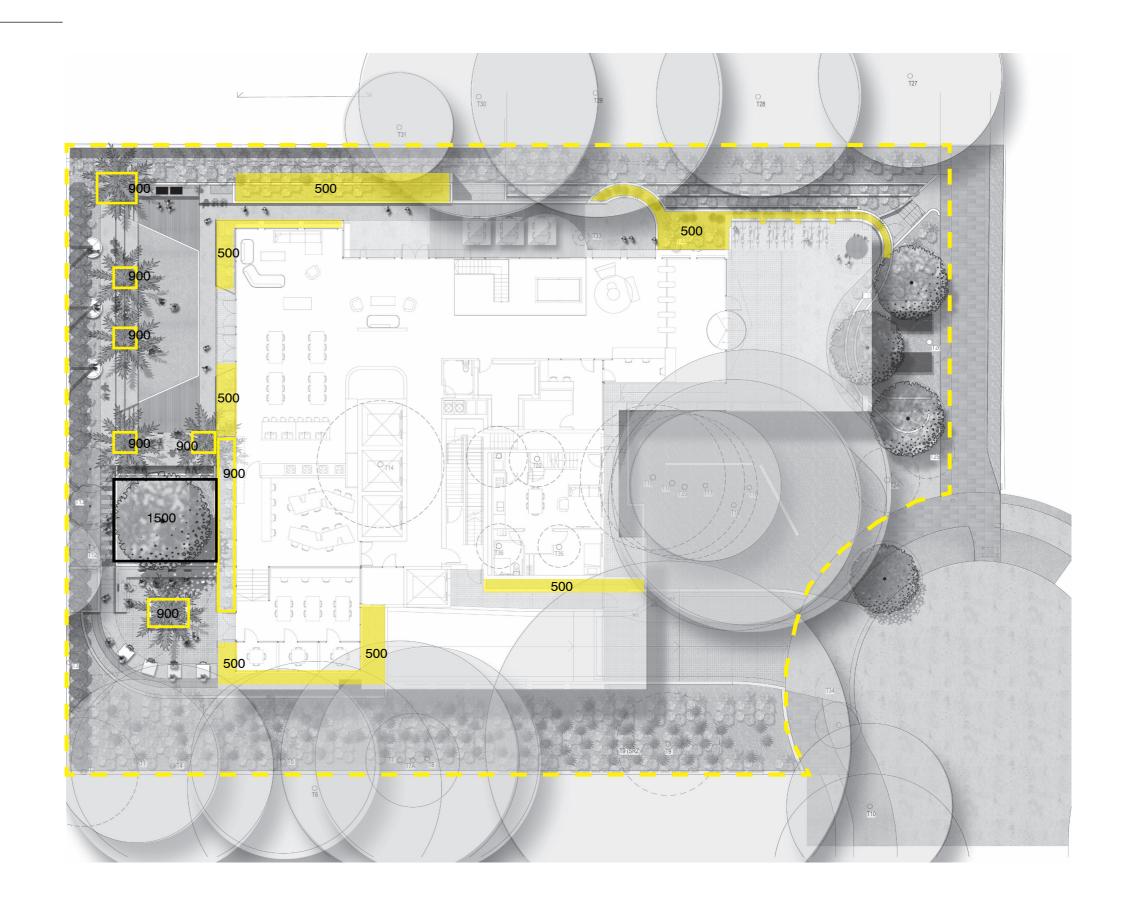




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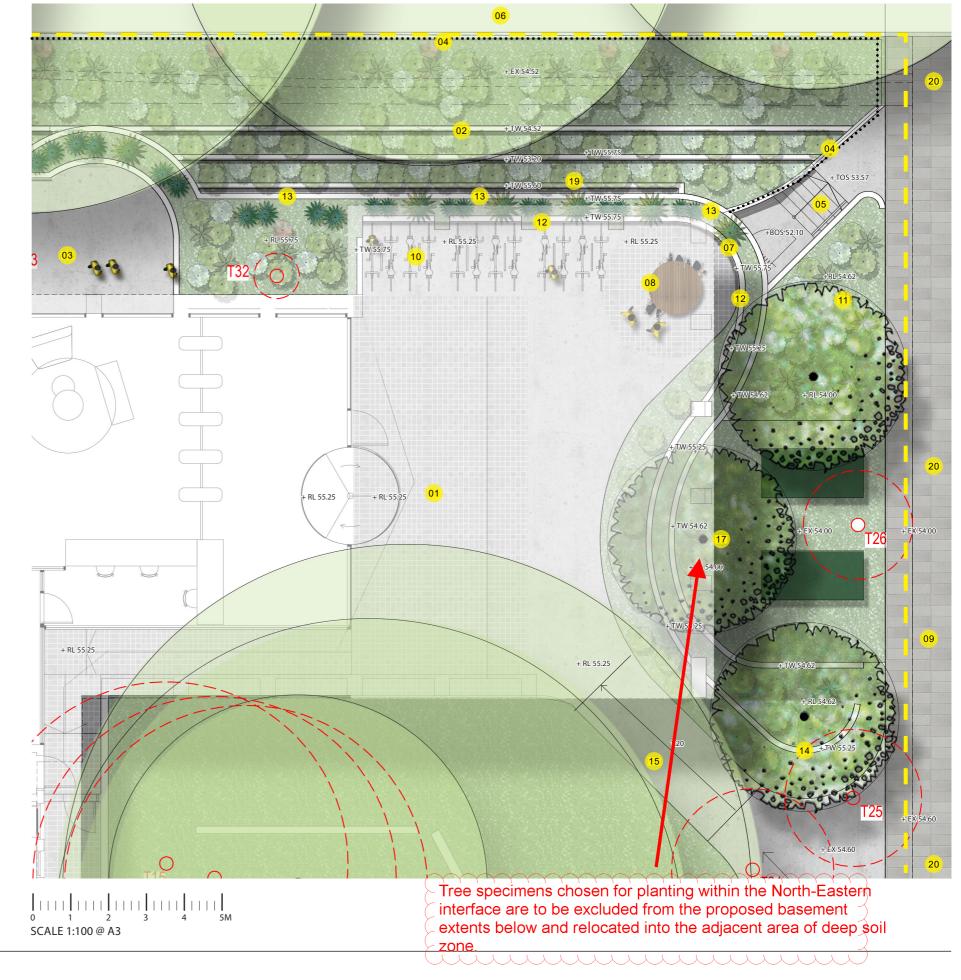
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#### Location Reference Plan

#### Legend

- Open circulation around foyer
- Terraced landscape walls and planting
- Outdoor social platform with park views
- Security line 1.8m Palisade fence
- Step access to path to lower level gym
- Neighbouring park
- Curved feature wall / refer Architects
- Circular seating element
- Widened public link (Granite paving as per DCP)
- Bike parking
- Mounded landscape
- Low wall (150mm) with glass balustrade 1100mm)
- Low planter with cascading plants over edge
- Proud curved entry wall with signage / lighting opportunity and low panting at base to soften path to wall interface
- 1:20 slope from Lachlan Ave to foyer level
- Entry feature statement wall with signage
- Entry trees in deep soil
- Substation
- Lower level / gym
- Lighting along this section is to be consistent with the lighting within Elouera Reserve including pole colour and type and luminaire type.



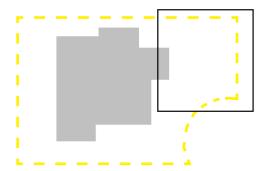


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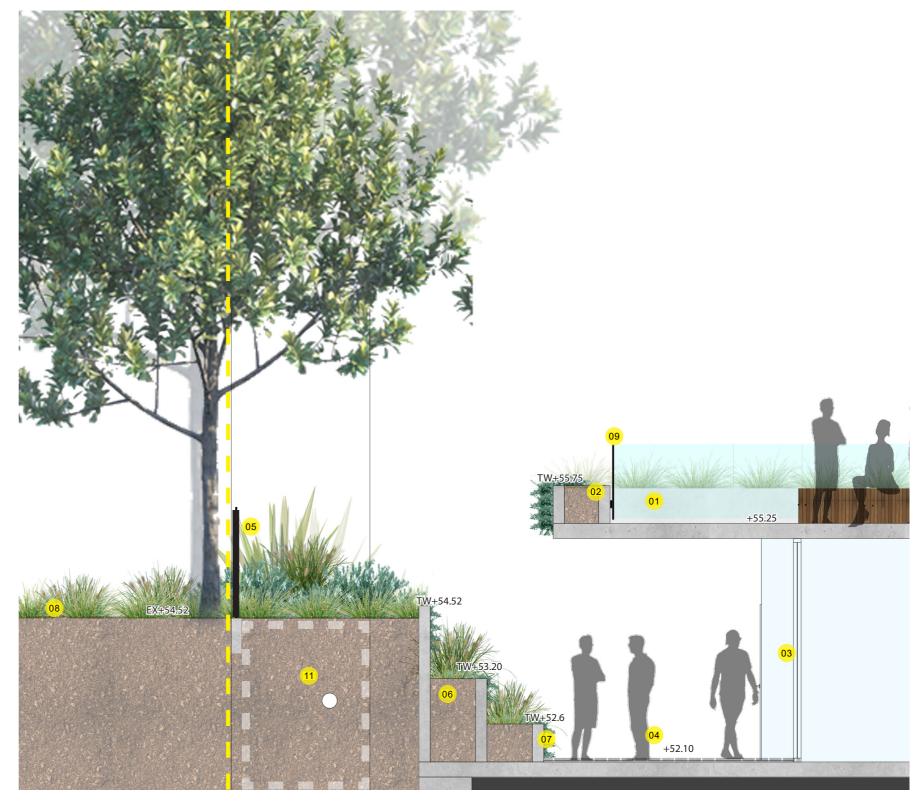


Location Reference Plan

#### Legend

- Upper plaza
- Low planting to retain park views
- Glass windows to gym
- Outdoor gym space
- 1.8m Powder coated metal palisade fence
- Terraced landscape
- Seating height retaining wall
- Existing Elouera Park
- 1000 Ht glass balustrade
- 1400mm Ht glass balustrade
- 1.8m wide Easement

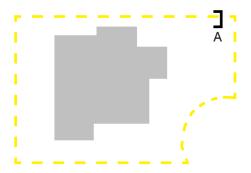Note: No wooded root plants will be planted in the easement over the Council pipe.



Section A - Northern Eastern Interface





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Location Reference Plan

#### Legend

- 01 1.1m circulation paths
- O2 Raised edge for planting
- O3 Access point
- Open lawn (Synthetic)
- 05 Decking
- 06 BBQ zone
- Seating steps for socialising
- OB Shade tolerant tree ferns
- 9 Boundary buffer planting
- 10 Step access to upper walkway
- 11 Upper walkway
- 12 Feature hanging seats

Note: No wooded root plants will be planted in the easement over the Council pipe.







Project /

23-25 LACHLAN AVE, MACQUARIE PARK, NSW 2123

LANDSCAPE DEVELOPMENT APPLICATION

North /


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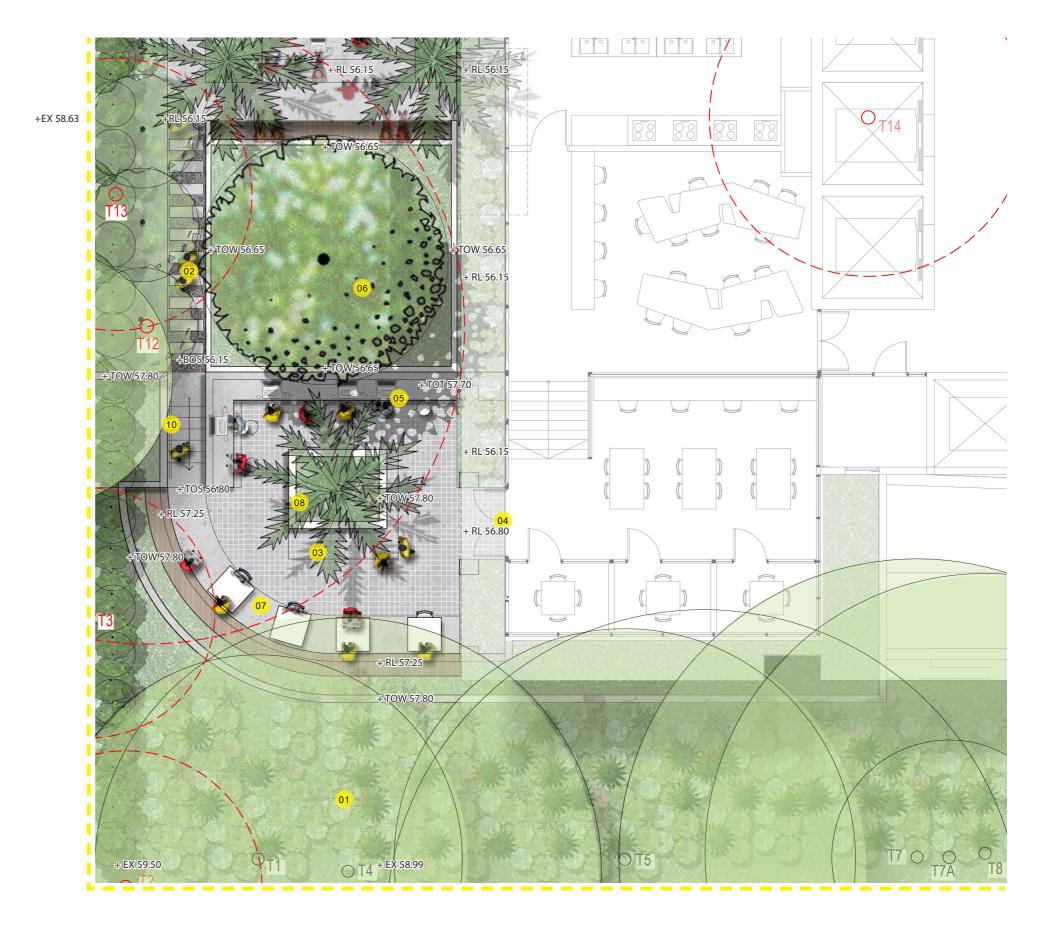
## 11 Detail Plan / Rear Courtyard 2 of 2



Location Reference Plan

#### Legend

- 01 5m offset / deep soil zone
- 62 Elevated walkway through landscaping
- Outdoor study zone
- Onnection to indoor study zone
- Bar height table with chairs for studying
- Buffer planting with medium tree between diverse outdoor zones
  - Soil Volume 54m3
- Orved seating element with mobile table and chairs
- OB Central raised planter with shade tree
- Existing trees retained along southern
- 10 Step access to upper study zone

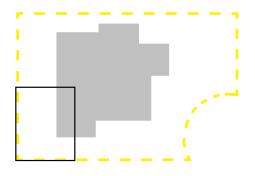






Project /

## 12 Landscape Section B

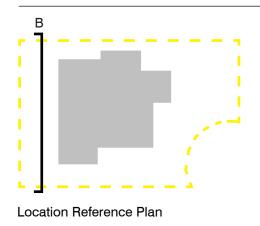

#### Legend

- 5m offset with existing trees
- Upper level quiet zone
- Buffer planting between outdoor zones
- Large planter with native planting / shade trees
- 05 Tree ferns
- 6 Elevated walkway behind
- O7 Social zone

- OB Seating steps
- period 
  Feature hanging seats for relaxing / socialising
- 0pen lawn
- 11 BBQ Zone









Project /

23-25 LACHLAN AVE, MACQUARIE PARK, NSW 2123

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Location Reference Plan

#### Legend

- Seating steps
- Feature hanging chairs
- Tree ferns
- BBQ zone
- Seating around BBQ zone
- Buffer planting in deep soil
- Open lawn (synthetic)
- **Building columns**
- 1.1m walkway
- Building access point
- Basement extent

Note: No wooded root plants will be planted in the easement over the Council pipe.





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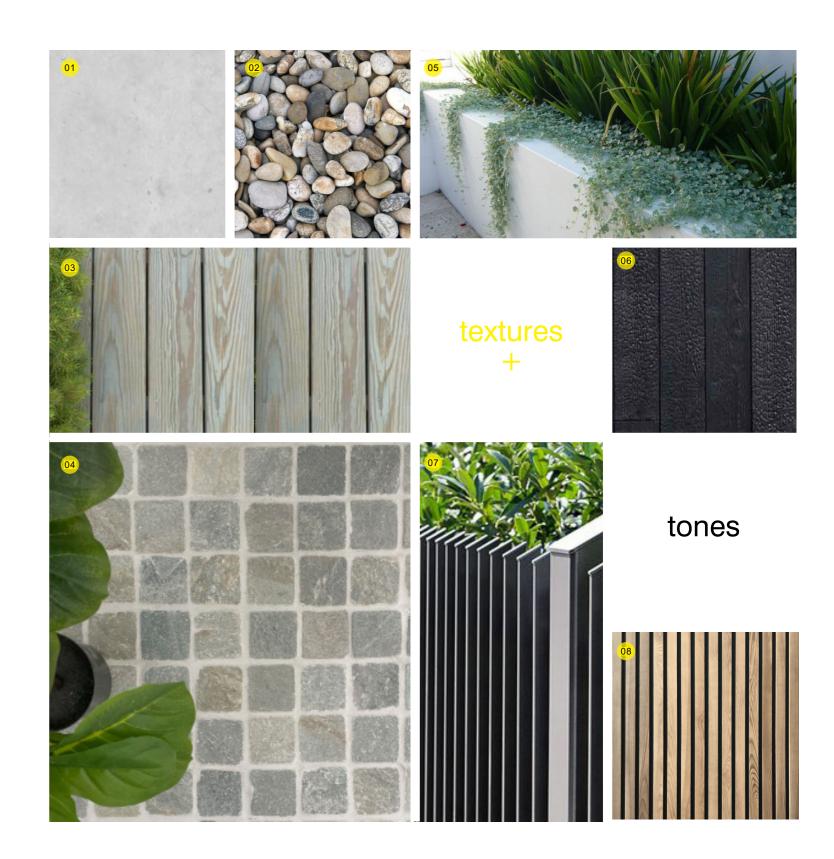
### Material Strategy

The pathways and pavement palette will have 2-3 different finishes to help residents navigate their way around the communal spaces. Continuity in their tones and subtle changes in their finishes will also help achieve a hierarchy of spaces from primary pathways to break out spaces for seating and socialising.

Walls and fencing will be diverse in their purpose from 1.8m timber boundary fences, low planter walls to illuminated signage walls with feature cladding. The materiality will unite with the architecture palette to achieve an overall familiar look for the residents.

### Legend

- Natural concrete for circulation paths
- Decorative pebbles
- Timber decking for amenity nodes
- Natural stone feature paving for seating zones
- Light rendered walls
- 1.8m Ht timber larchlap boundary fence painted charcoal
- 1.8m Ht security fencing and gates
- Timber batten cladding





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April 2022 Date / Scale / As Shown Issue /

### Furniture + Lighting Strategy

Both the furniture and lighting products have been selected as a family kit of parts all with the same visual attributes to achieve a strong and unifying design style. Natural timber finishes accompanied by black steel frames and lighting products achieve a contemporary finish that tie in with both Architectural and Landscape Materials Palettes.


### Legend

- Bike Racks
- **Bollards**
- **Rubbish Bins**
- Bench Seat with Armrests
- Curved Bench Seat on Wall
- Seating with Back and Armrest
- Picnic setting seats
- Wall Lights
- Garden Uplight








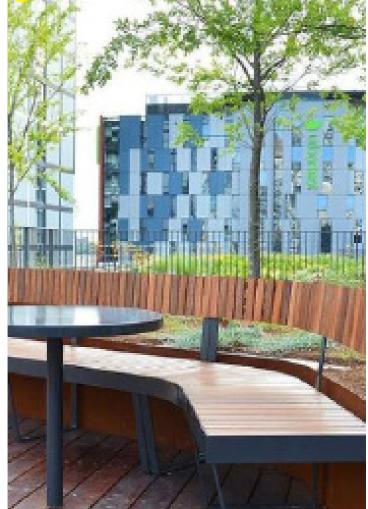

furniture

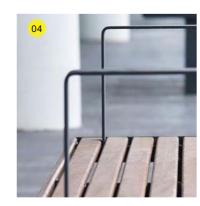











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Scale / Issue /

April 2022 As Shown

#### Planting Character

Low maintenance planting clearly defined garden beds and areas are proposed. Planting will be functional but also create an effective aesthetical outcome. Feature plantings will reinforce the local character and bring rich texture and diversity to garden beds adjacent paths and common spaces.

### Legend

- Native trees
- Shrubs and Accents
- Grasses and Rushes
- Ferns and Cycads
- Groundcovers
- Shade tolerant species






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LandFX Landscape Architecture Barcam Mac Park Pty Ltd

April 2022 Scale / As Shown



#### **LEGEND**

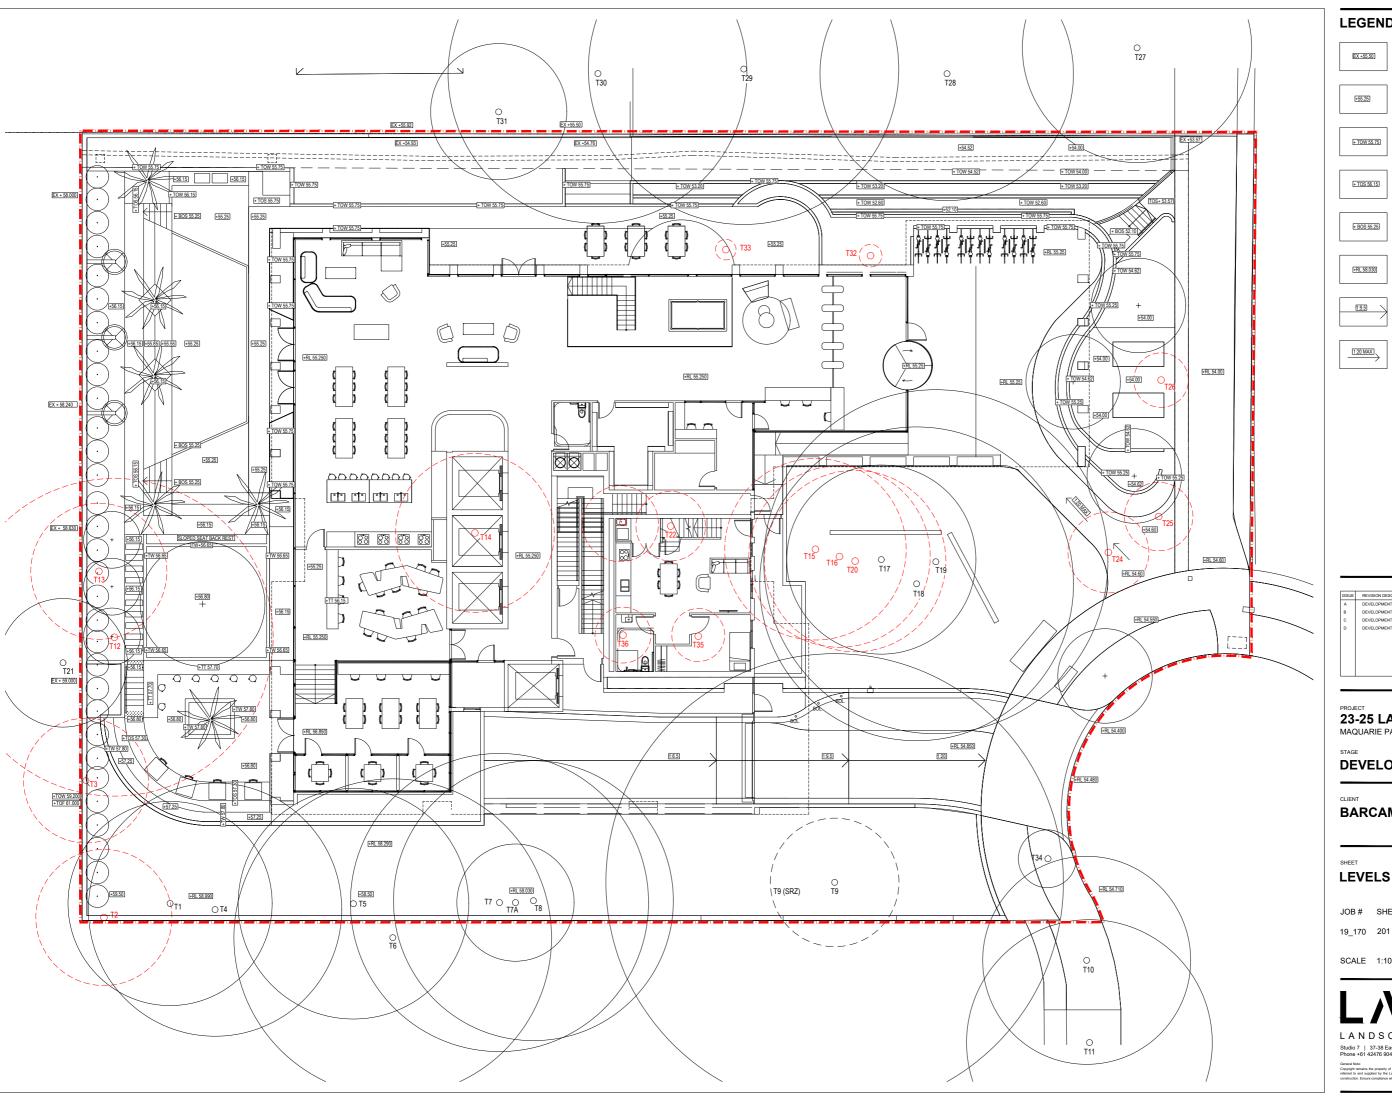EX +55.50

REFER LANDSCAPE PLANS

PROPOSED LANDSCAPE LEVELS +55.25 REFER LANDSCAPE PLANS

PROPOSED TOP OF WALL LEVELS REFER LANDSCAPE PLANS

PROPOSED TOP OF STEP LEVELS REFER LANDSCAPE PLANS

PROPOSED BOTTOM OF STEP LEVELS REFER LANDSCAPE PLANS

LEVELS AS PROVIDED FROM ARCHITECTS REFER LANDSCAPE PLANS

GRADING (ARCHITECTS) 1:9.5 REFER LANDSCAPE PLANS

GRADING (ARCHITECTS) REFER LANDSCAPE PLANS

ISSUE	REVISION DESCRIPTION	DRAWN	CHECK	DATE
А	DEVELOPMENT APPLICATION	TC	CT	06.03.2021
В	DEVELOPMENT APPLICATION	СТ	СТ	22.04.2021
c	DEVELOPMENT APPLICATION	DO	СТ	23.08.2021
D	DEVELOPMENT APPLICATION	DO	СТ	04.04.2021

23-25 LACHLAN AVENUE MAQUARIE PARK, NSW, 2113, AUSTRALIA

**DEVELOPMENT APPLICATION** 

**BARCAM MAC PARK PTY LTD** 

#### **LEVELS PLAN**

JOB # SHEET # ISSUE

NORTH

SCALE 1:100 @ A1 0 1 2 3 4 5



Studio 7 | 37-38 East Esplanade Manly | Sydney | NSW 2095 Phone +61 42476 9049 | Email info@landfx.com.au | Web www.l

O D E	BOTANIC NAME	COMMON NAME	MATURE SIZE	PROPOSED	QUANTITY
	TREES & PALMS				
Ca TI	Cupaniopsis anacardioides Tristaniopsis 'Luscious'	Tuckeroo Luscious Water Gum	12 x 3 10 x 5	200L 200L	1 5
Btg De Mct Px Wf	SHRUBS AND ACCENTS Bambusa textilis gracilis Doryanthes excelsa Metrosideros collina tahiiti Philodendron xanadu Westringia fruticosa	Slender Weavers Bamboo Gymea Lily NZ Christmas Bush Xanadu Coastal Rosemary	6 x 2 3 x 1.5 1.5 x 1 1 x 1 1.5 x 2.0	300mm 200mm 200mm 200mm 200mm	31 93 78 186 93
Lt Lm Pl	GRASSES AND RUSHES Lomandra 'Tanika' Liriope muscari Poa labillardieri 'Eskdale'	Mat Rush Lilyturf Tussock Grass	0.6 × 0.6 0.3 × 0.4 0.7 × 0.6	150mm 150mm 150mm	820 247 432
Bsl Cc Da	FERNS AND CYCADS  Blechnum Silver Lady Fern Cyathea cooperi Dicksonia antarctica	Silver Lady Fern Tree Fern Scaly Tree Fern	1.5 x 1.5 5 x 2 4 x 2	200mm 300mm 300mm	42 21 1
Mp Vh Cg	GROUNDCOVERS AND CLIMBERS Myoporum parvifolium Viola hederacea Casuarina glauca	Creeping Boobialla Native Violet Cousin It	0.15 x spreading 0.2 x 0.5 0.2 x spreading	150mm 150mm 150mm	63 268 20

All Proposed Tree Species selected from Ryde DCP Open Spaces Tree List

Note: No wooded root plants will be planted in the easement over the Council pipe.



ISSUE	REVISION DESCRIPTION	DRAWN	CHECK	DATE
Α	DEVELOPMENT APPLICATION	TC	CT	06.03.2021
В	DEVELOPMENT APPLICATION	CT	CT	22.04.2021
С	DEVELOPMENT APPLICATION	DO	CT	23.08.2021
D	DEVELOPMENT APPLICATION	DO	CT	04.04.2021

PROJEC

23-25 LACHLAN AVENUE MAQUARIE PARK, NSW, 2113, AUSTRALIA

STAGE

**DEVELOPMENT APPLICATION** 

CLIENT

BARCAM MAC PARK PTY LTD

SHEET

SOFTWORKS -PLANTING SCHEDULE

JOB# SHEET# ISSUE

SUE NOR


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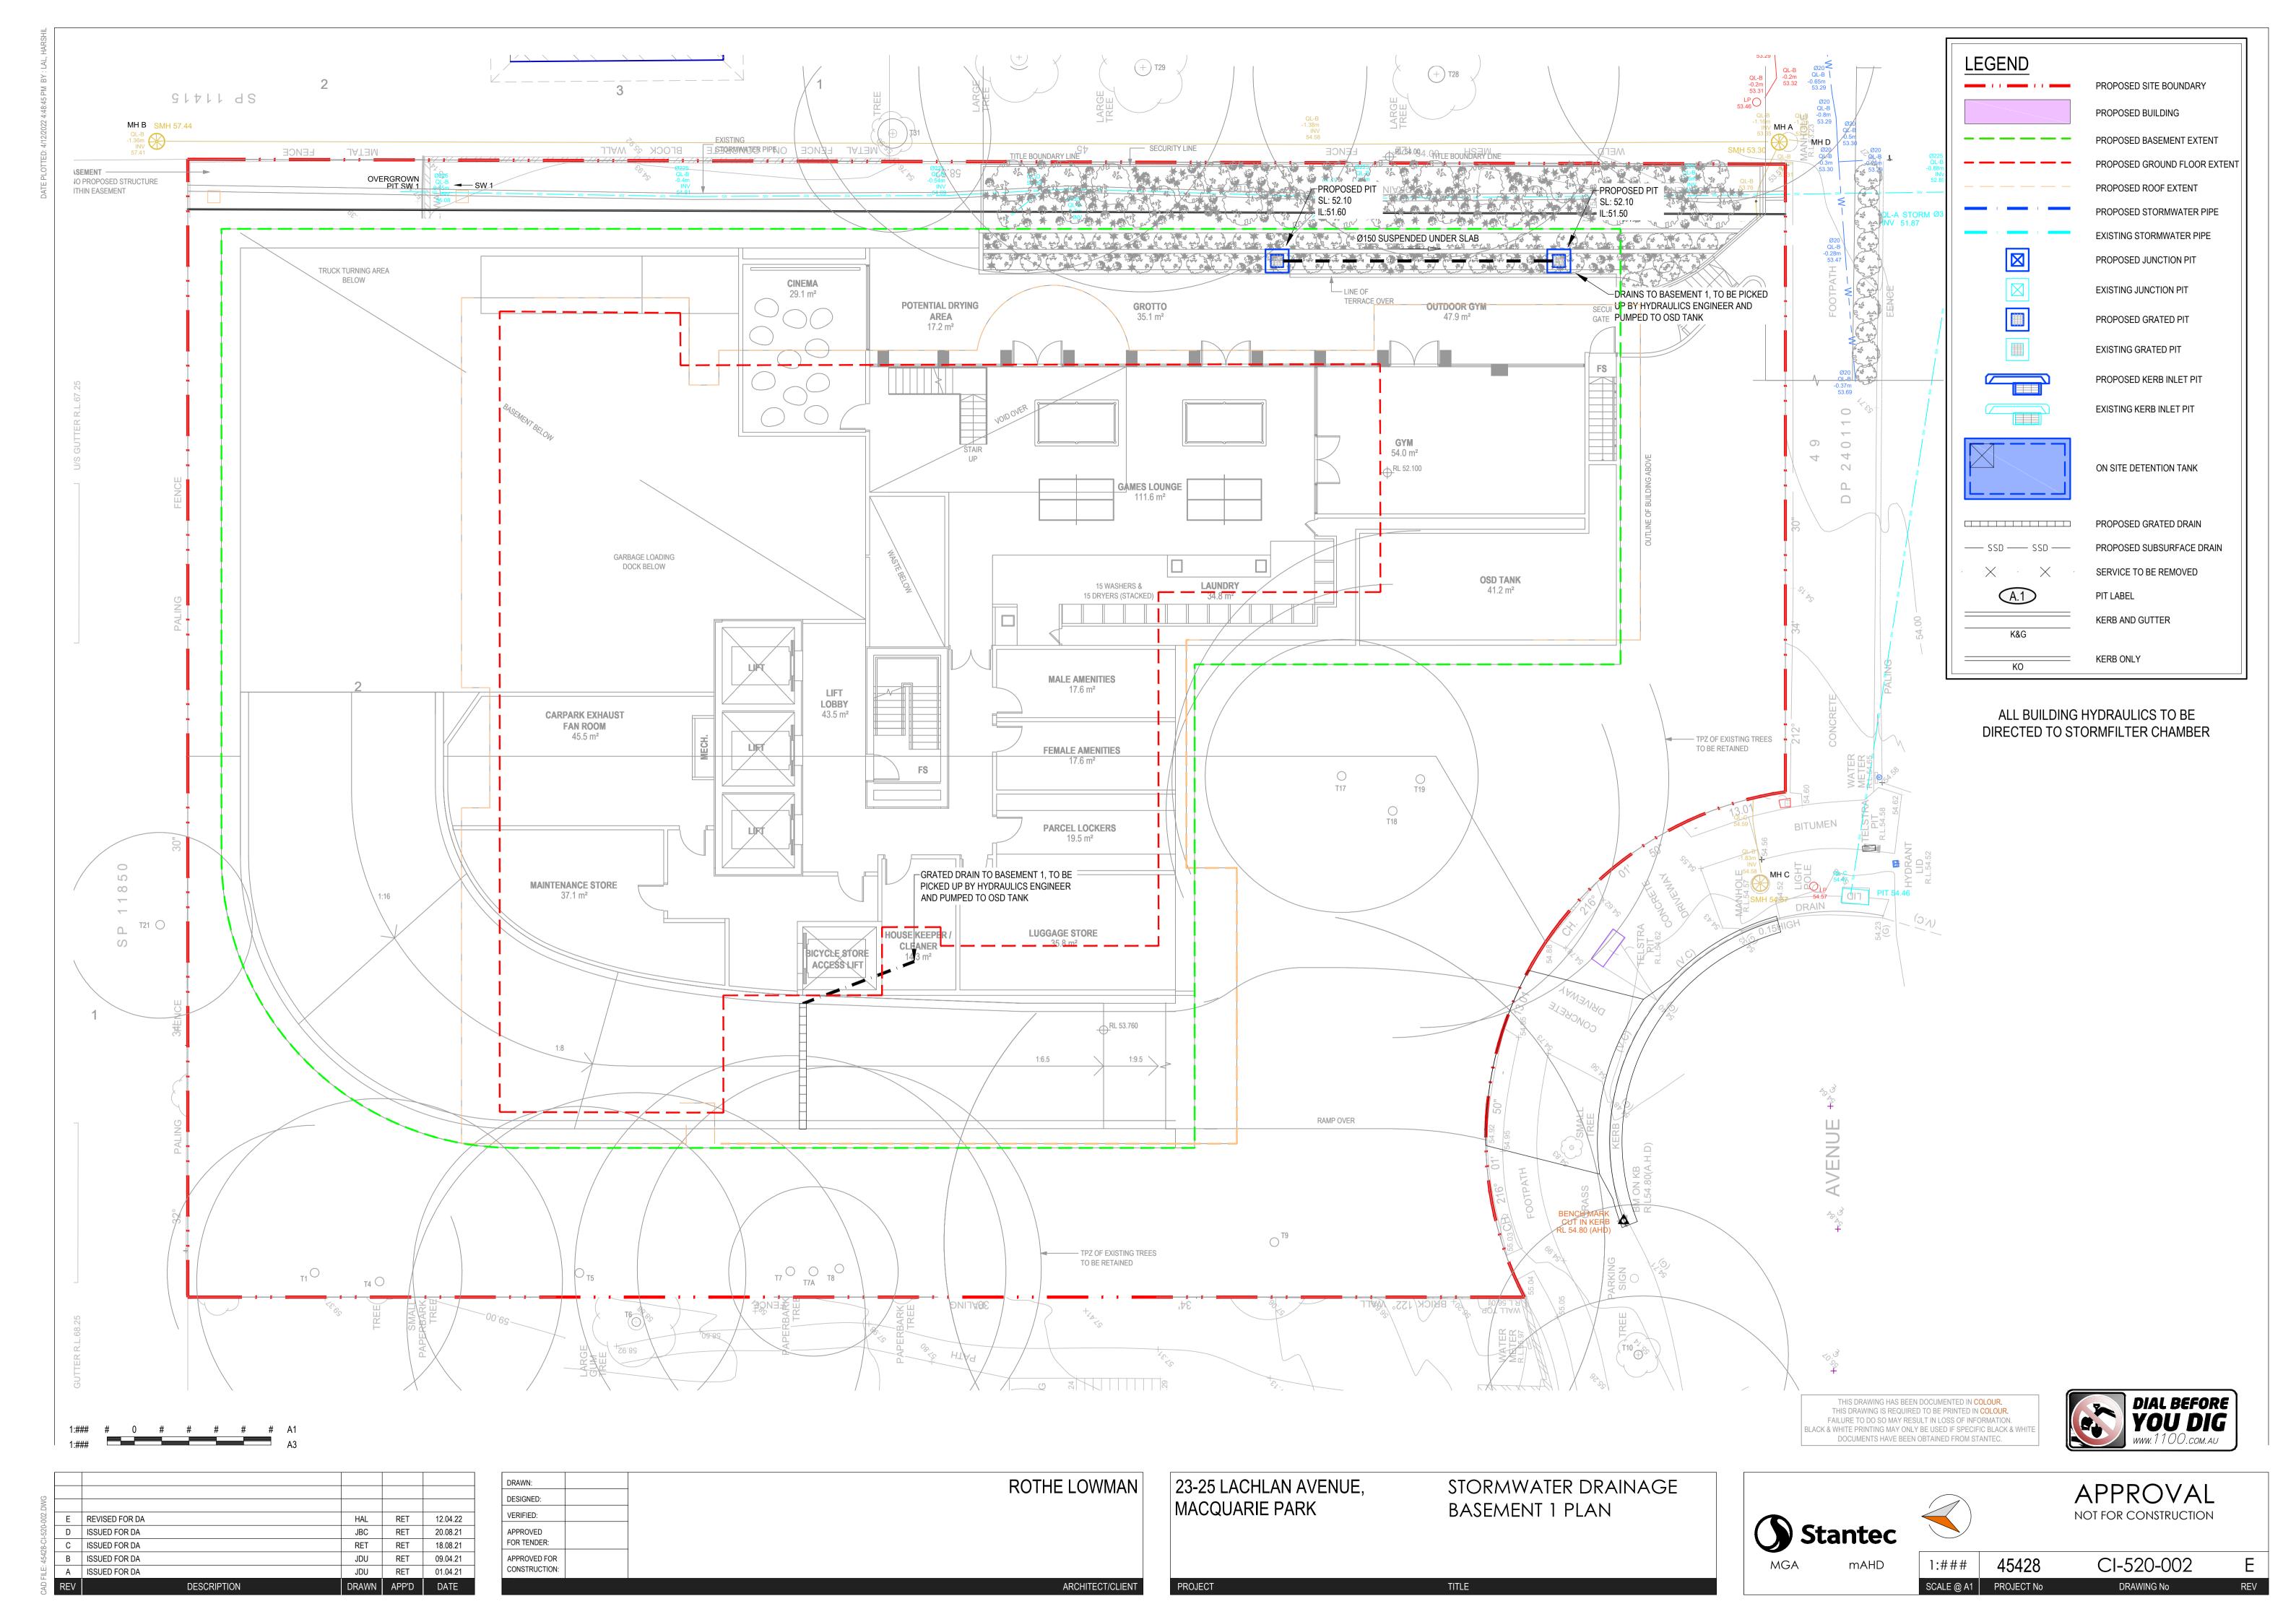
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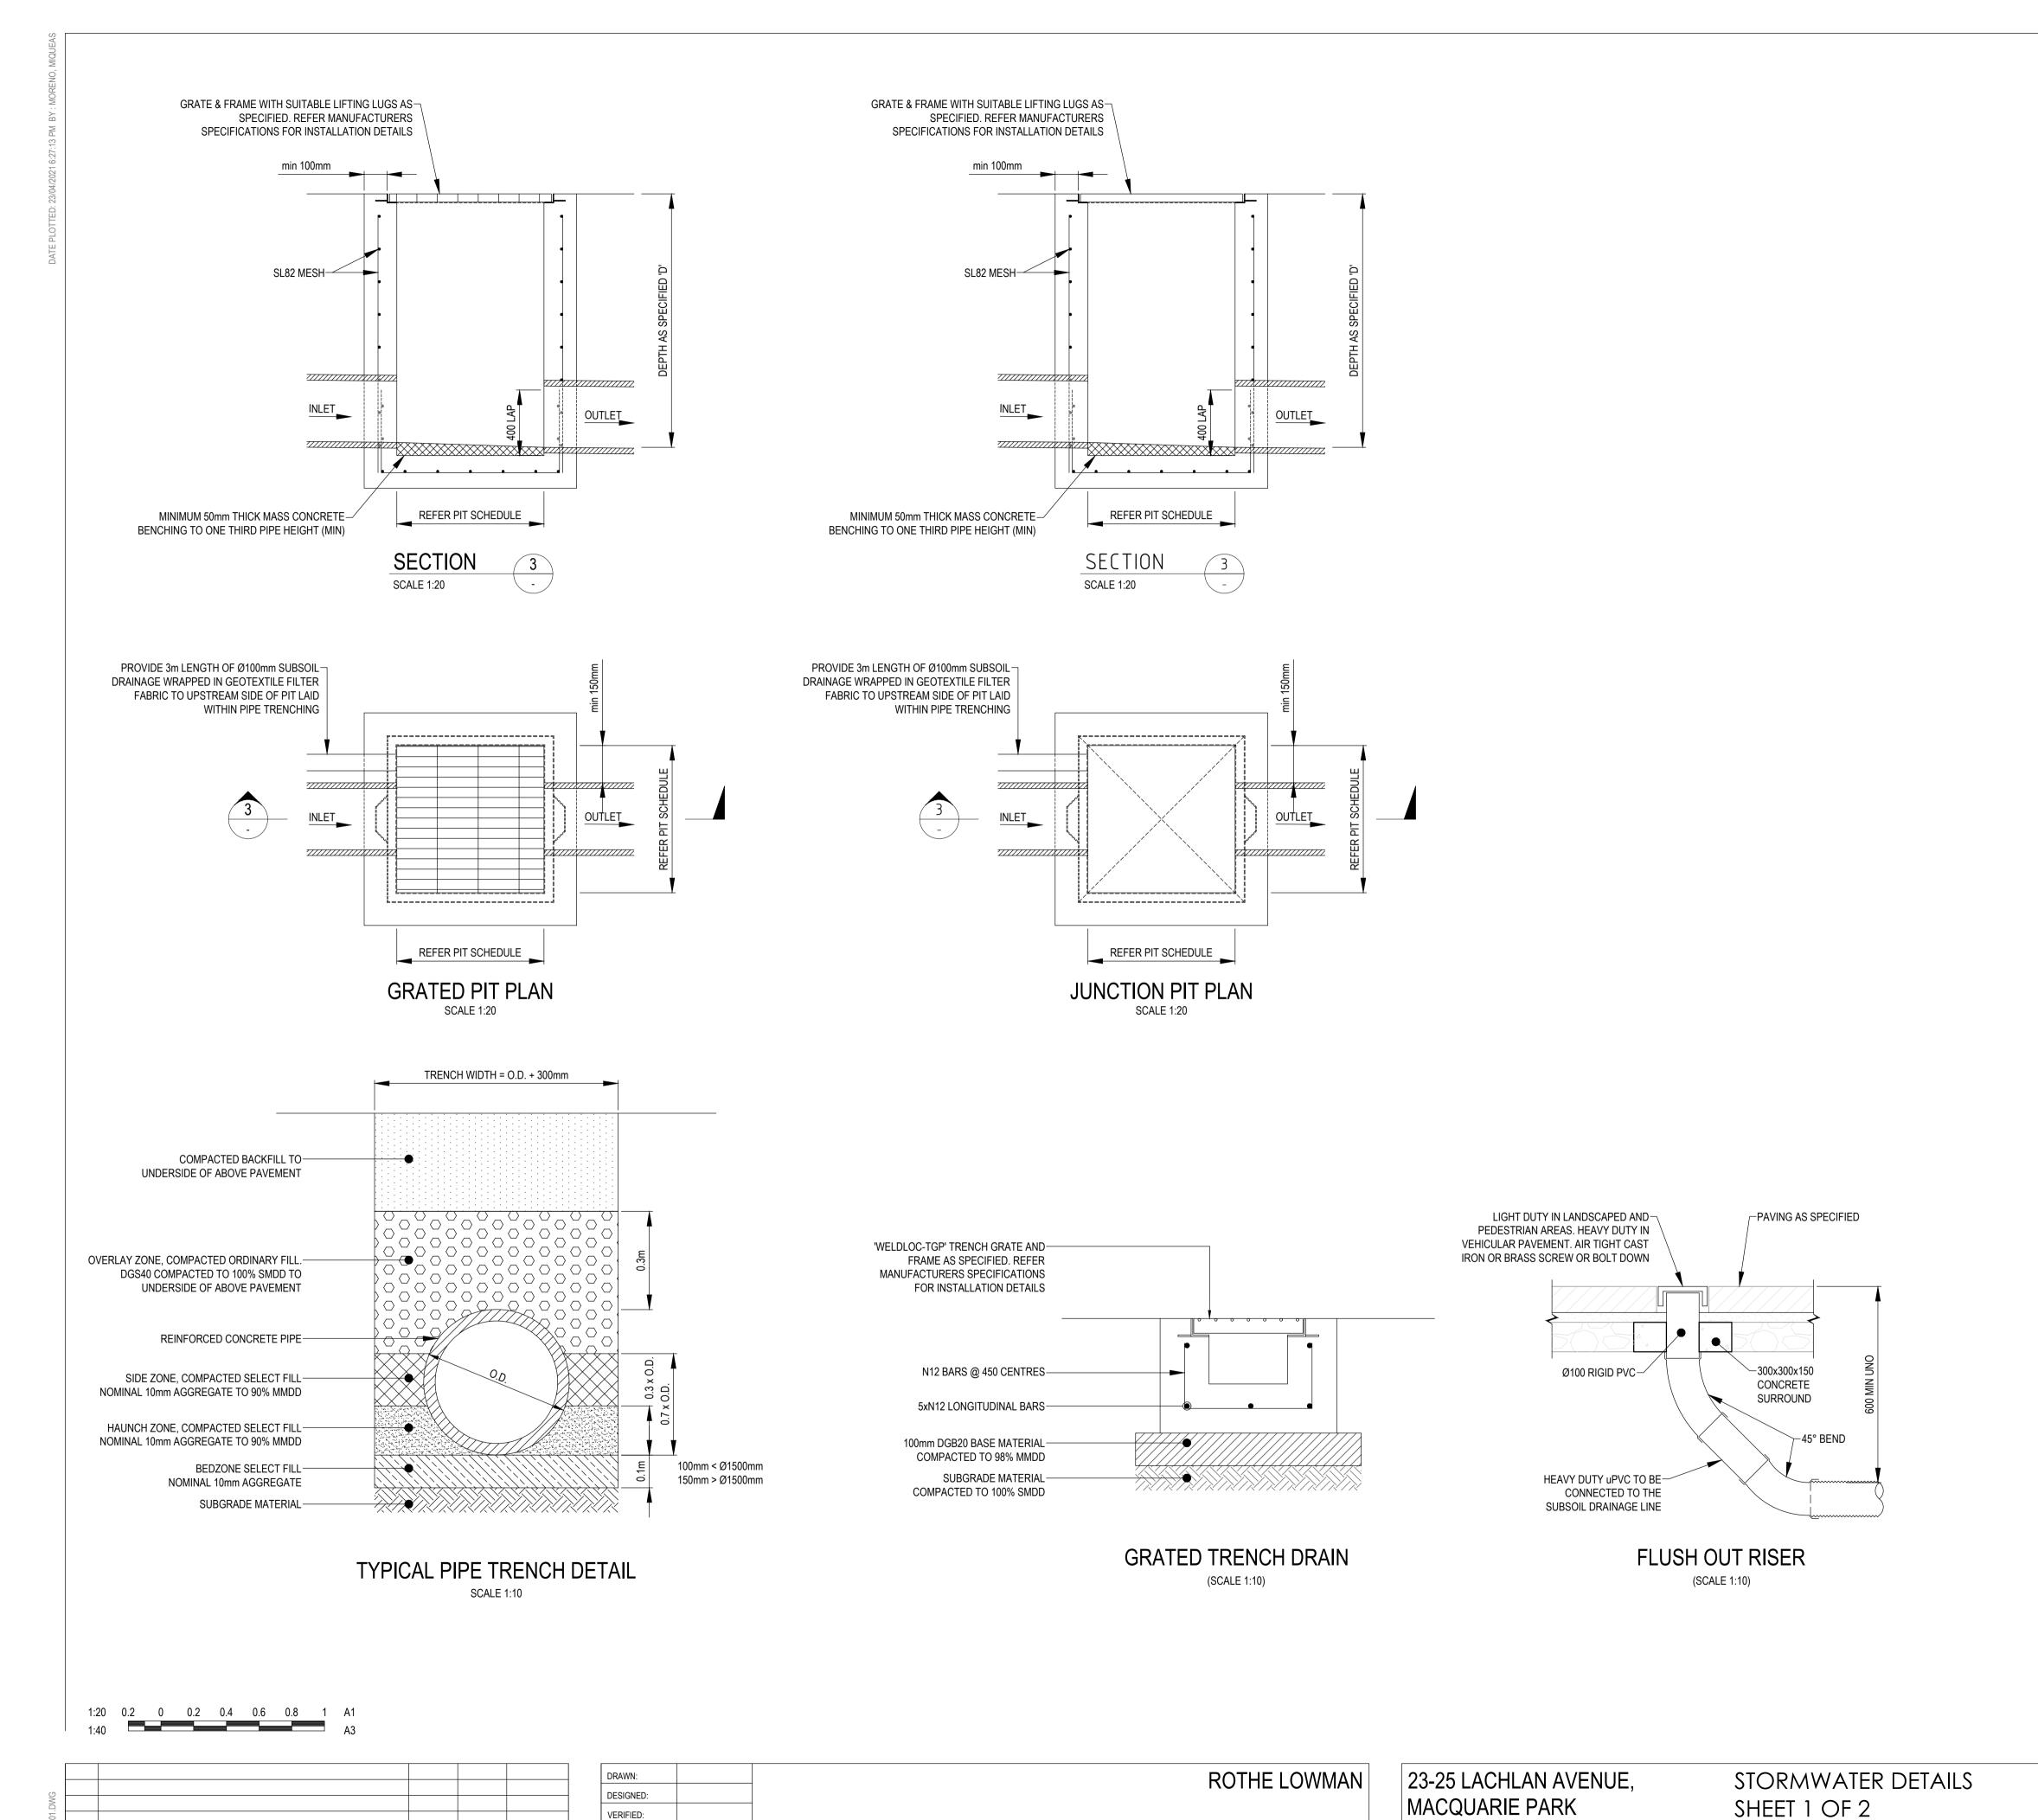


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ARCHITECT/CLIENT

PROJECT

APPROVED FOR TENDER:

APPROVED FOR

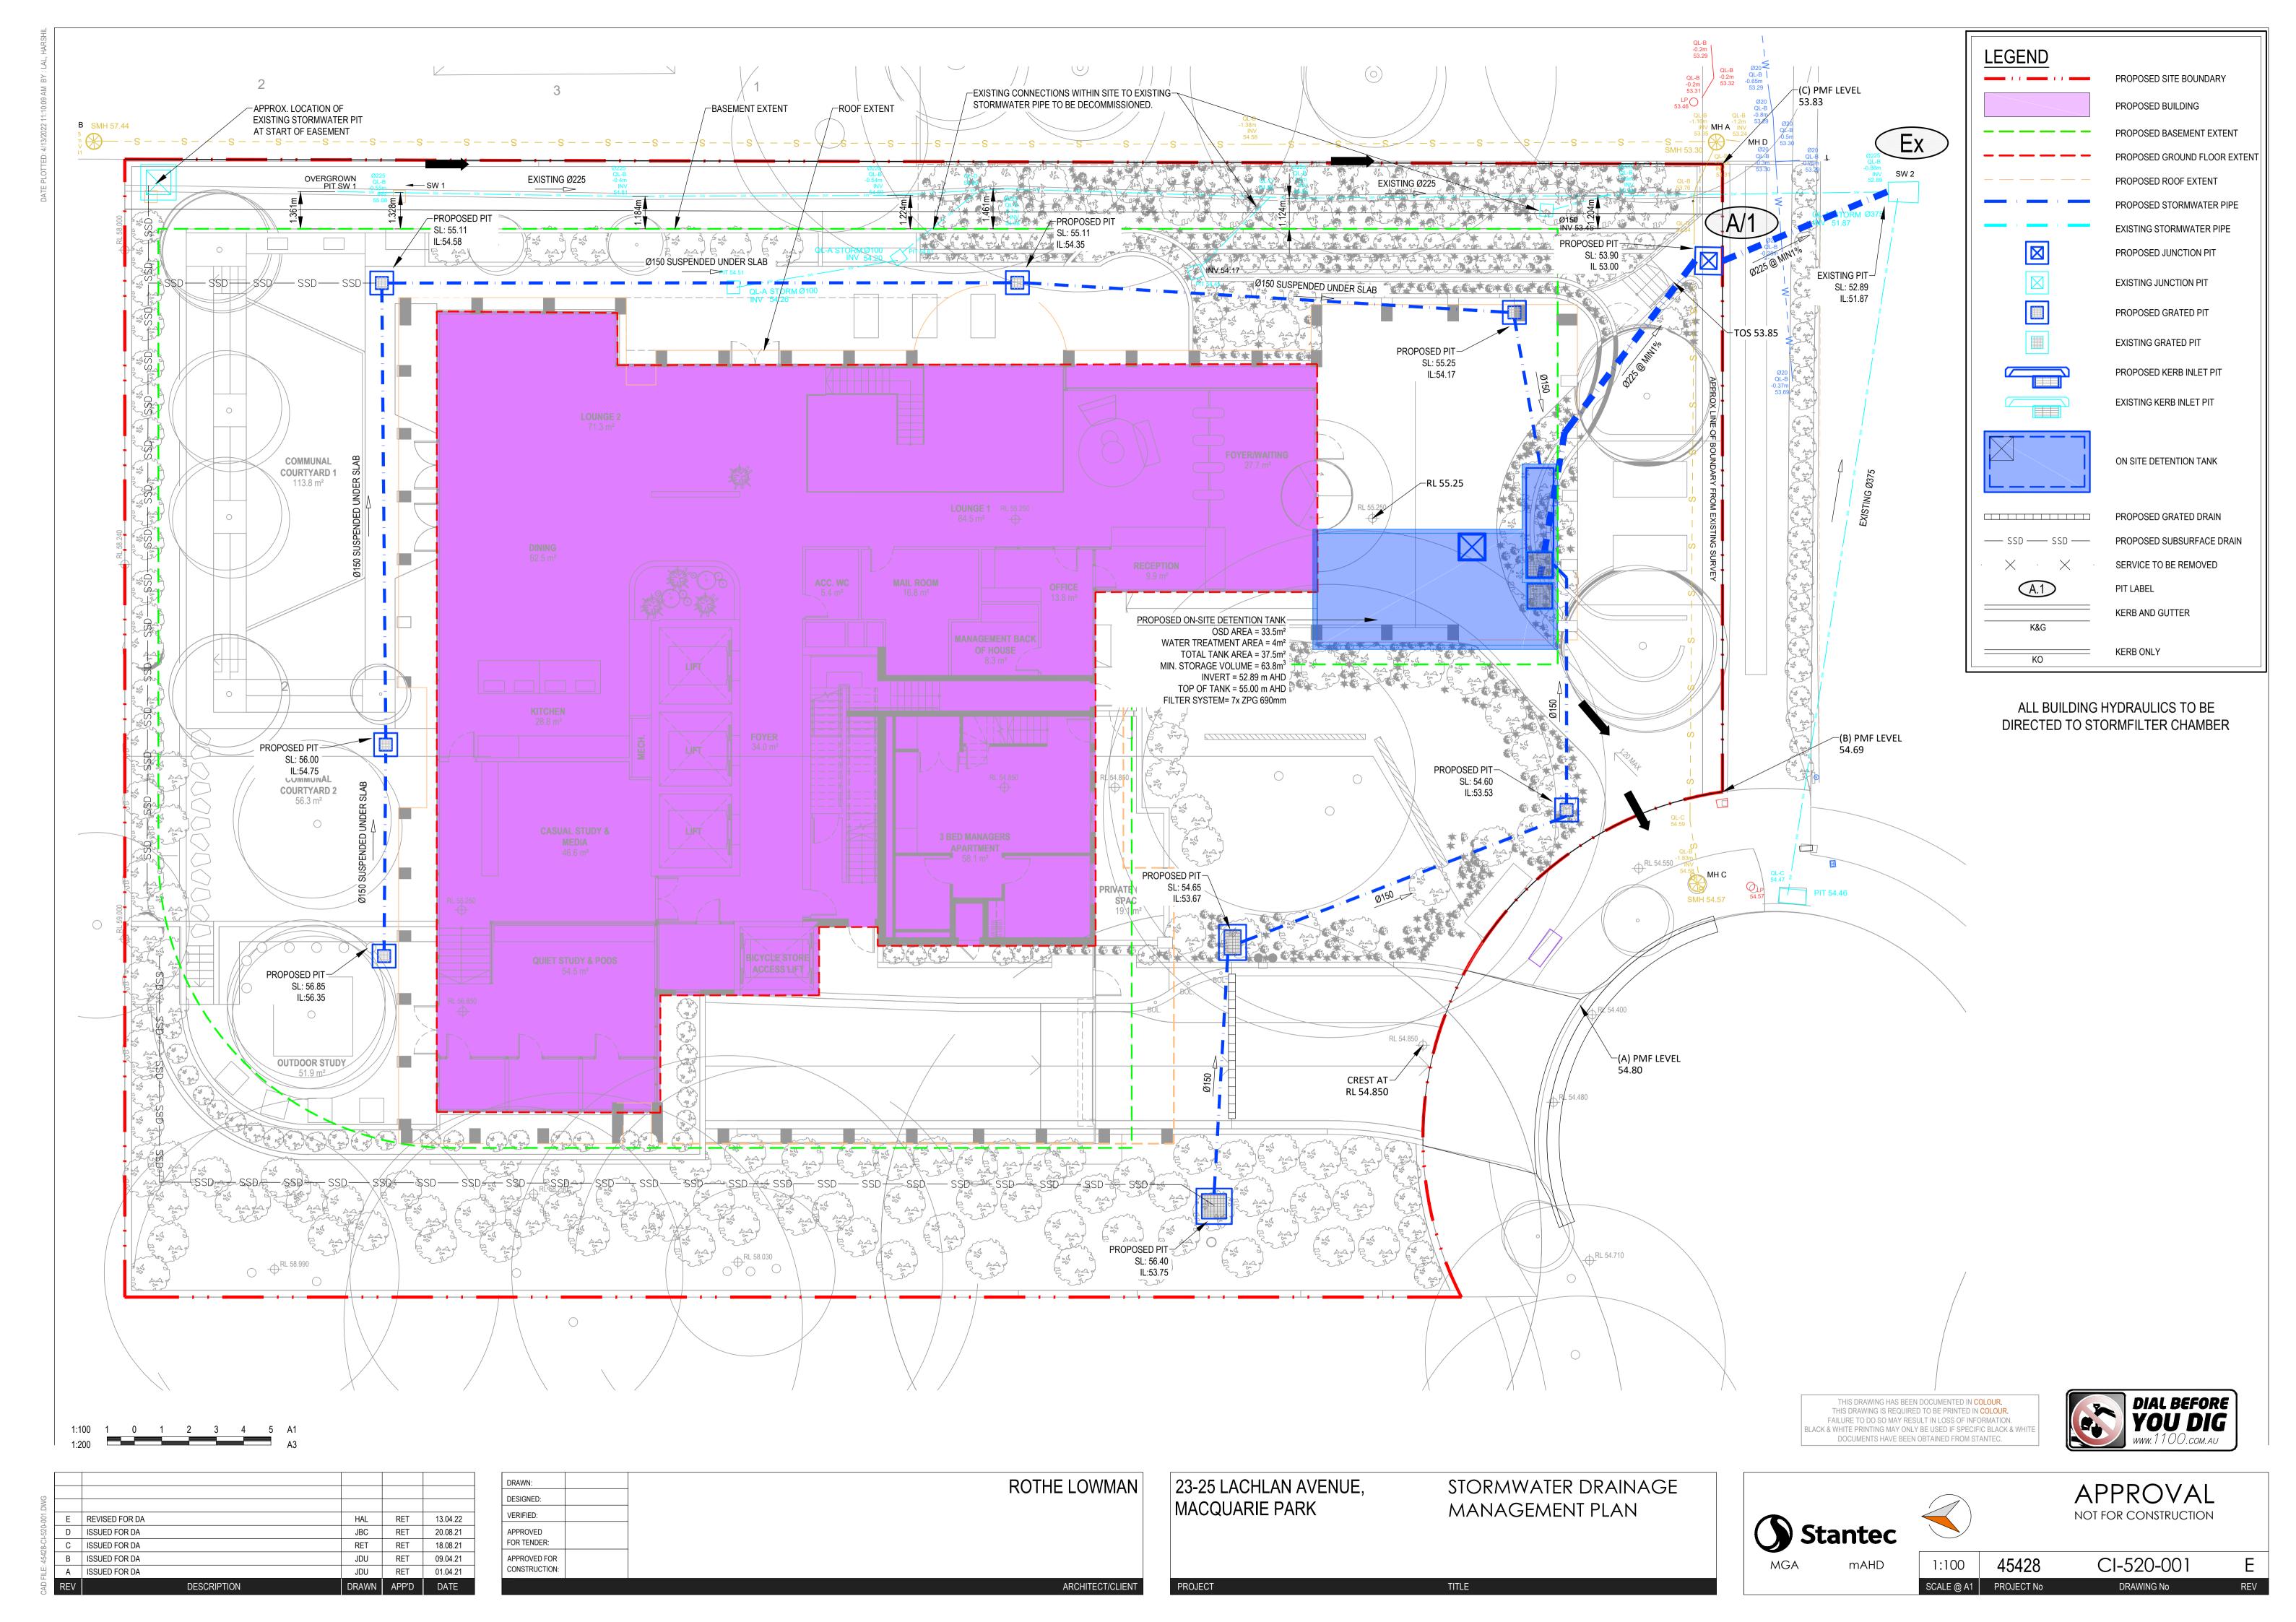CONSTRUCTION:

RET 23.04.21 RET 09.04.21

JDU RET 01.04.21

REVISED FOR DA

DESCRIPTION

B ISSUED FOR DA

A ISSUED FOR DA


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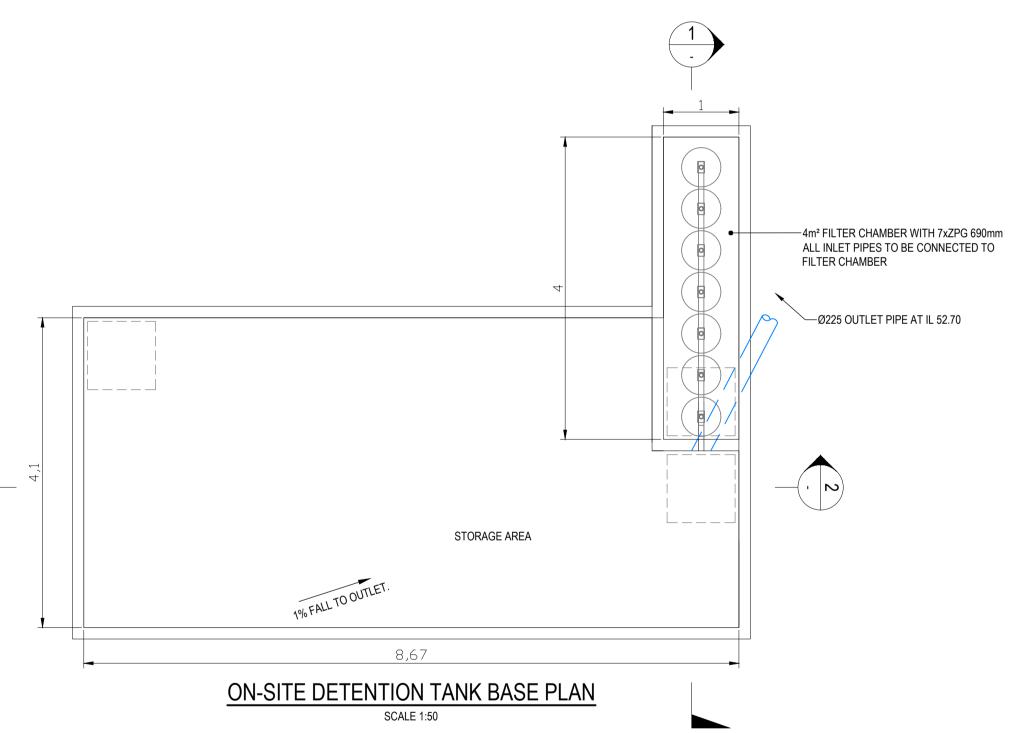



**Stantec** mAHD

**APPROVAL** 


NOT FOR CONSTRUCTION 45428 CI-526-001 1:20 SCALE @ A1 PROJECT No DRAWING No



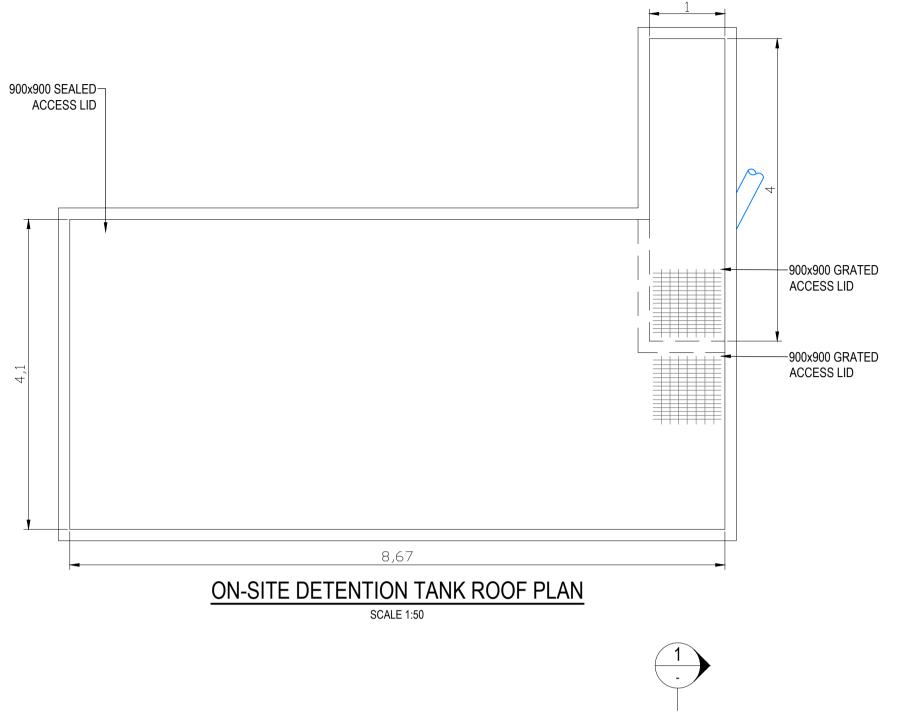

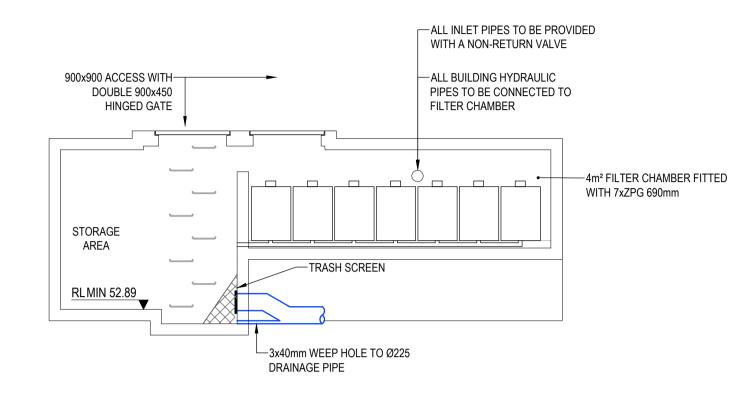



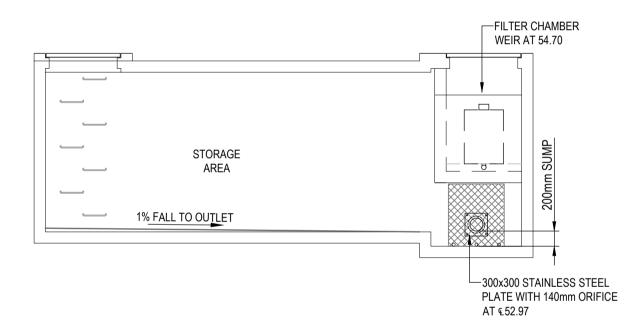

ON-SITE DETENTION TANK - SECTION



1:50 0.5 0 0.5 1 1.5 2 2.5 A1 1:100 A3

DRAWN:

DESIGNED:

VERIFIED:

APPROVED
FOR TENDER:

APPROVED FOR CONSTRUCTION:

ARCHITECT/CLIENT

23-25 LACHLAN AVENUE, STORMWATER DETAILS MACQUARIE PARK SHEET 2 OF 2

PROJECT TITLE

